Lake Placid / Whiteface Mountain KOA Holiday - Riverside

5644 NYS Route 86, Wilmington, NY 12997

PREPARED FOR:



Kampgrounds of America, Inc. 550 N 31st Street Billings, MT 59101 (509)440-1104



REGIONAL MAP

PREPARED BY:

LANDSCAPE ARCHITECT/ENGINEER:






SUBMISSION:

SPECIAL USE PERMIT / SITE PLAN AND VARIANCE APPLICATIONS

September 20, 2022



SCALE: N.T.S.

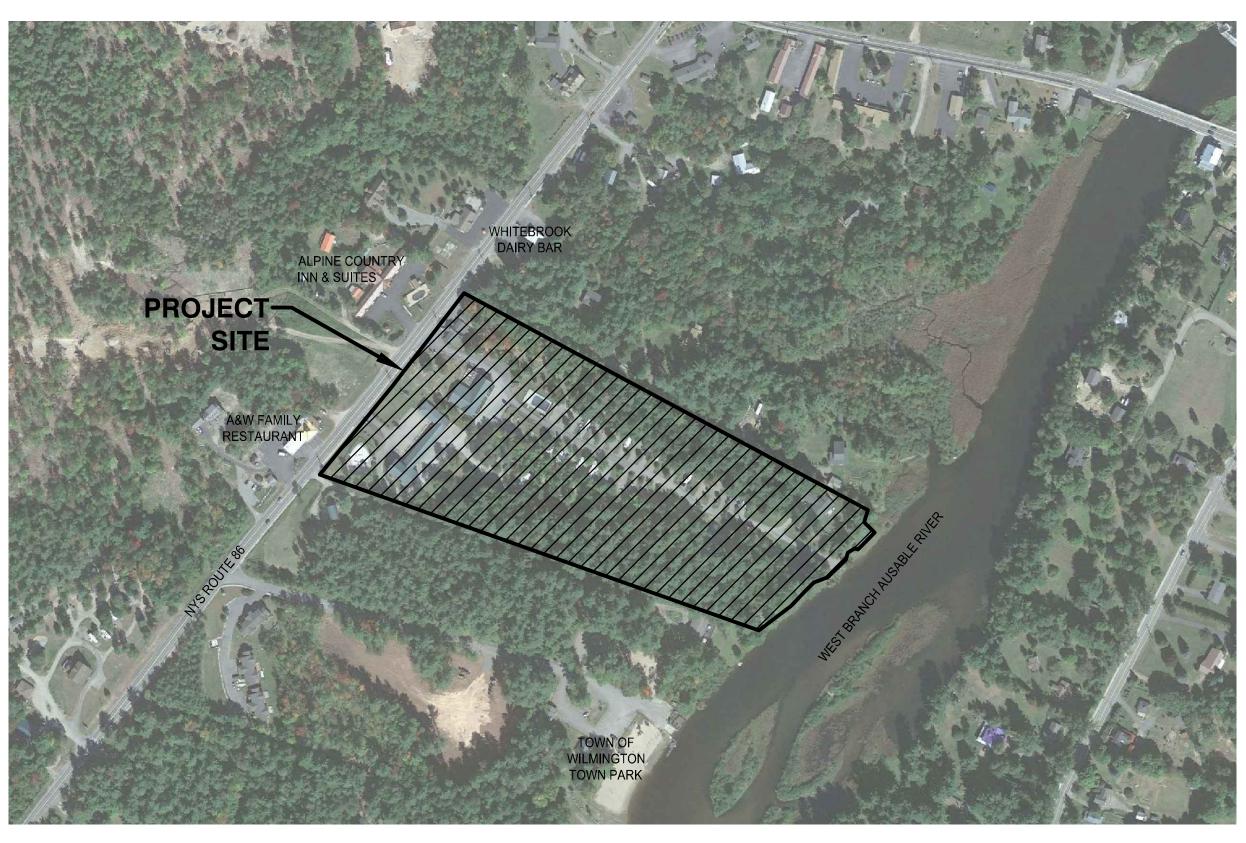

PROJECT VICINITY MAP

SURVEYORS:



Ausfeld & Waldruff Land Surveyors LLP 323 Clinton Street Schenectady, NY (518) 346-1595



Adirondack Surveying PLLC PO Box 334 Jay, New York 12941 (518) 946-7571

ARCHITECT:



Cushing Terrell



SHEET INDEX:

SURVEY

SITE / TOPOGRAPHIC SURVEY
ALTA SURVEY INCLUDING WETLAND / RIVE

LANDSCAPE ARCHITECTURE

100	OVERALL SITE PLAN
101	VARIANCE DIAGRAM
200	SITE DEMOLITION PLAN
300	EROSION & SEDIMENT CONTROL PLAN
400	SITE LAYOUT PLAN
500	SITE MATERIALS PLAN
600	SITE GRADING & DRAINAGE PLAN
700	SITE PLANTING PLAN
800-803	SITE DETAILS
804	NOTES
900	PHOTOMETRIC LIGHTING DIAGRAM

SEWER AND WATER ENGINEERING UTILITY PLAN C-100


ELECTRICAL

ELECTRICAL DISTRIBUTION PLAN E-100


ARCHITECTURE


CVR	COVER
A-101	FLOOR PLAN
A-201	ELEVATIONS
A-301	SECTIONS AND ROOF PLAN
A-401	LIGHTING PLAN


ER EDGE

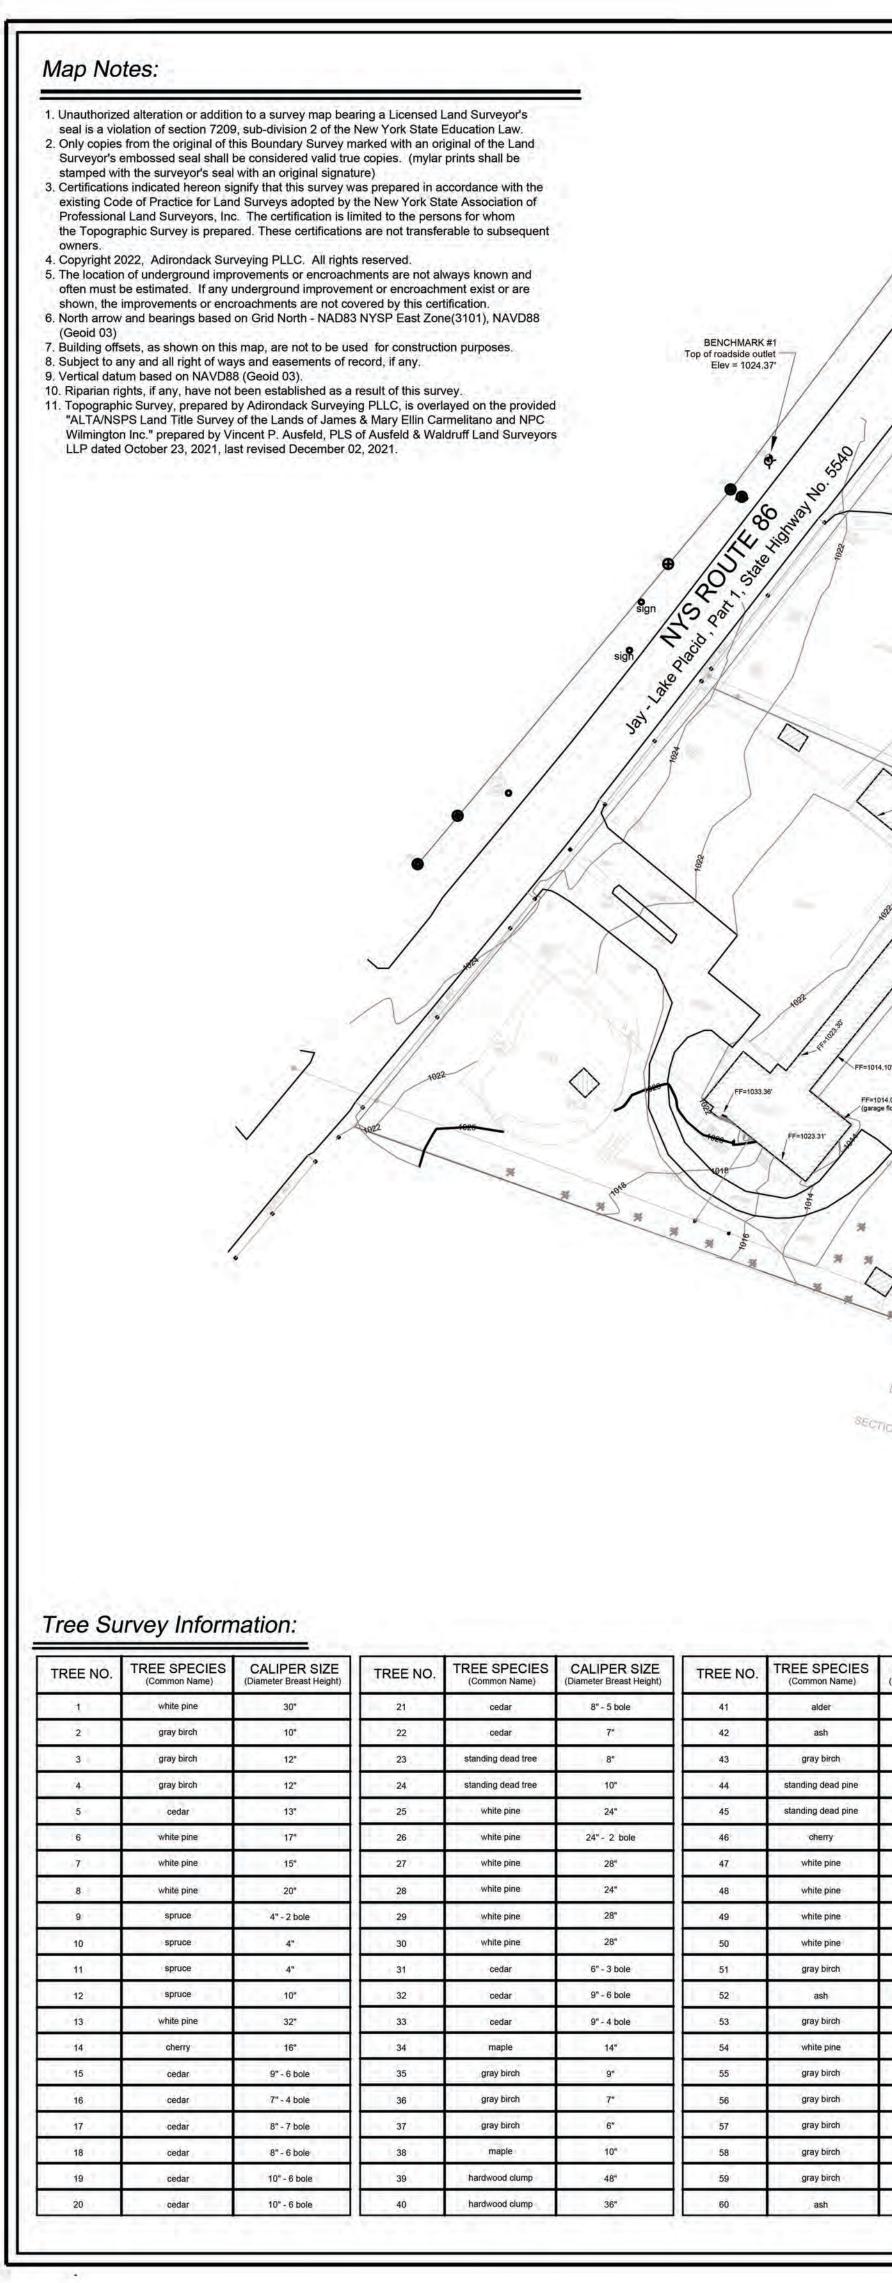


	1022 1018 1020 1018 1000 1000 1000 1000	PF=1024.50	FF=1015.51" FF=1015.12"	Love Contraction of the second		SAMANTHA SIS BECTON 25:05 BLOCK		FF=1005.85"	NOTAL ARE	DANIEL SO FI SECTION 28:05 T SECTION 28:05 T S	
505 BLOCK5 LC	⊋ <i>т.т</i> 8							1002		$\sum_{i=1}^{n}$	BENCHMA Maghub 12
CALIPER SIZE (Diameter Breast Height)	TREE NO.	TREE SPECIES (Common Name)	CALIPER SIZE (Diameter Breast Height)						Z	1	Magnub 12 on easterly white oine l
4" 8"	61	ash gray birch	4" 10"							1.	4
8" 8"	62 63	gray birch ash	10" 5"								1
8" 6"	64	ash	5"								
6"	65	ash	6"								
8"	66	ash	7"								
5"	67	gray birch	7"								
24" 34"	68	gray birch white pine	5" 24" - 2 bole								
34" 32"	69 70	gray birch	24" - 2 bole 8"								
6"	71	gray birch	7"	-			-				
6"	72	gray birch	5"	TREE NO.	TREE SPECIES (Common Name)	(Diameter Breast Height)					
7"	73	gray birch	8"	81	white pine	22" 38"	-				
26" 12"	74	white pine white pine	28" 16"	82	white pine maple	38" 6"	-				
12" 8"	75 76	white pine gray birch	16" 7"	83 84	maple white pine	6" 26"	1				
o 10"	77	standing dead ash	7"	85	gray birch	7"	1		0	1/2 1	
10" - 2 bole	78	standing dead ash	6"	86	gray birch	9" 40" - 2 kale	-				2
9" 7"	79 80	hardwood clump white pine	18" 28"	87 88	gray birch poplar	12" - 2 bole 8"			ò	25 50 Sca	100 ale: 1 Inch
<i>T</i> "	80	white pine	28"	88	popiar	8"				302	

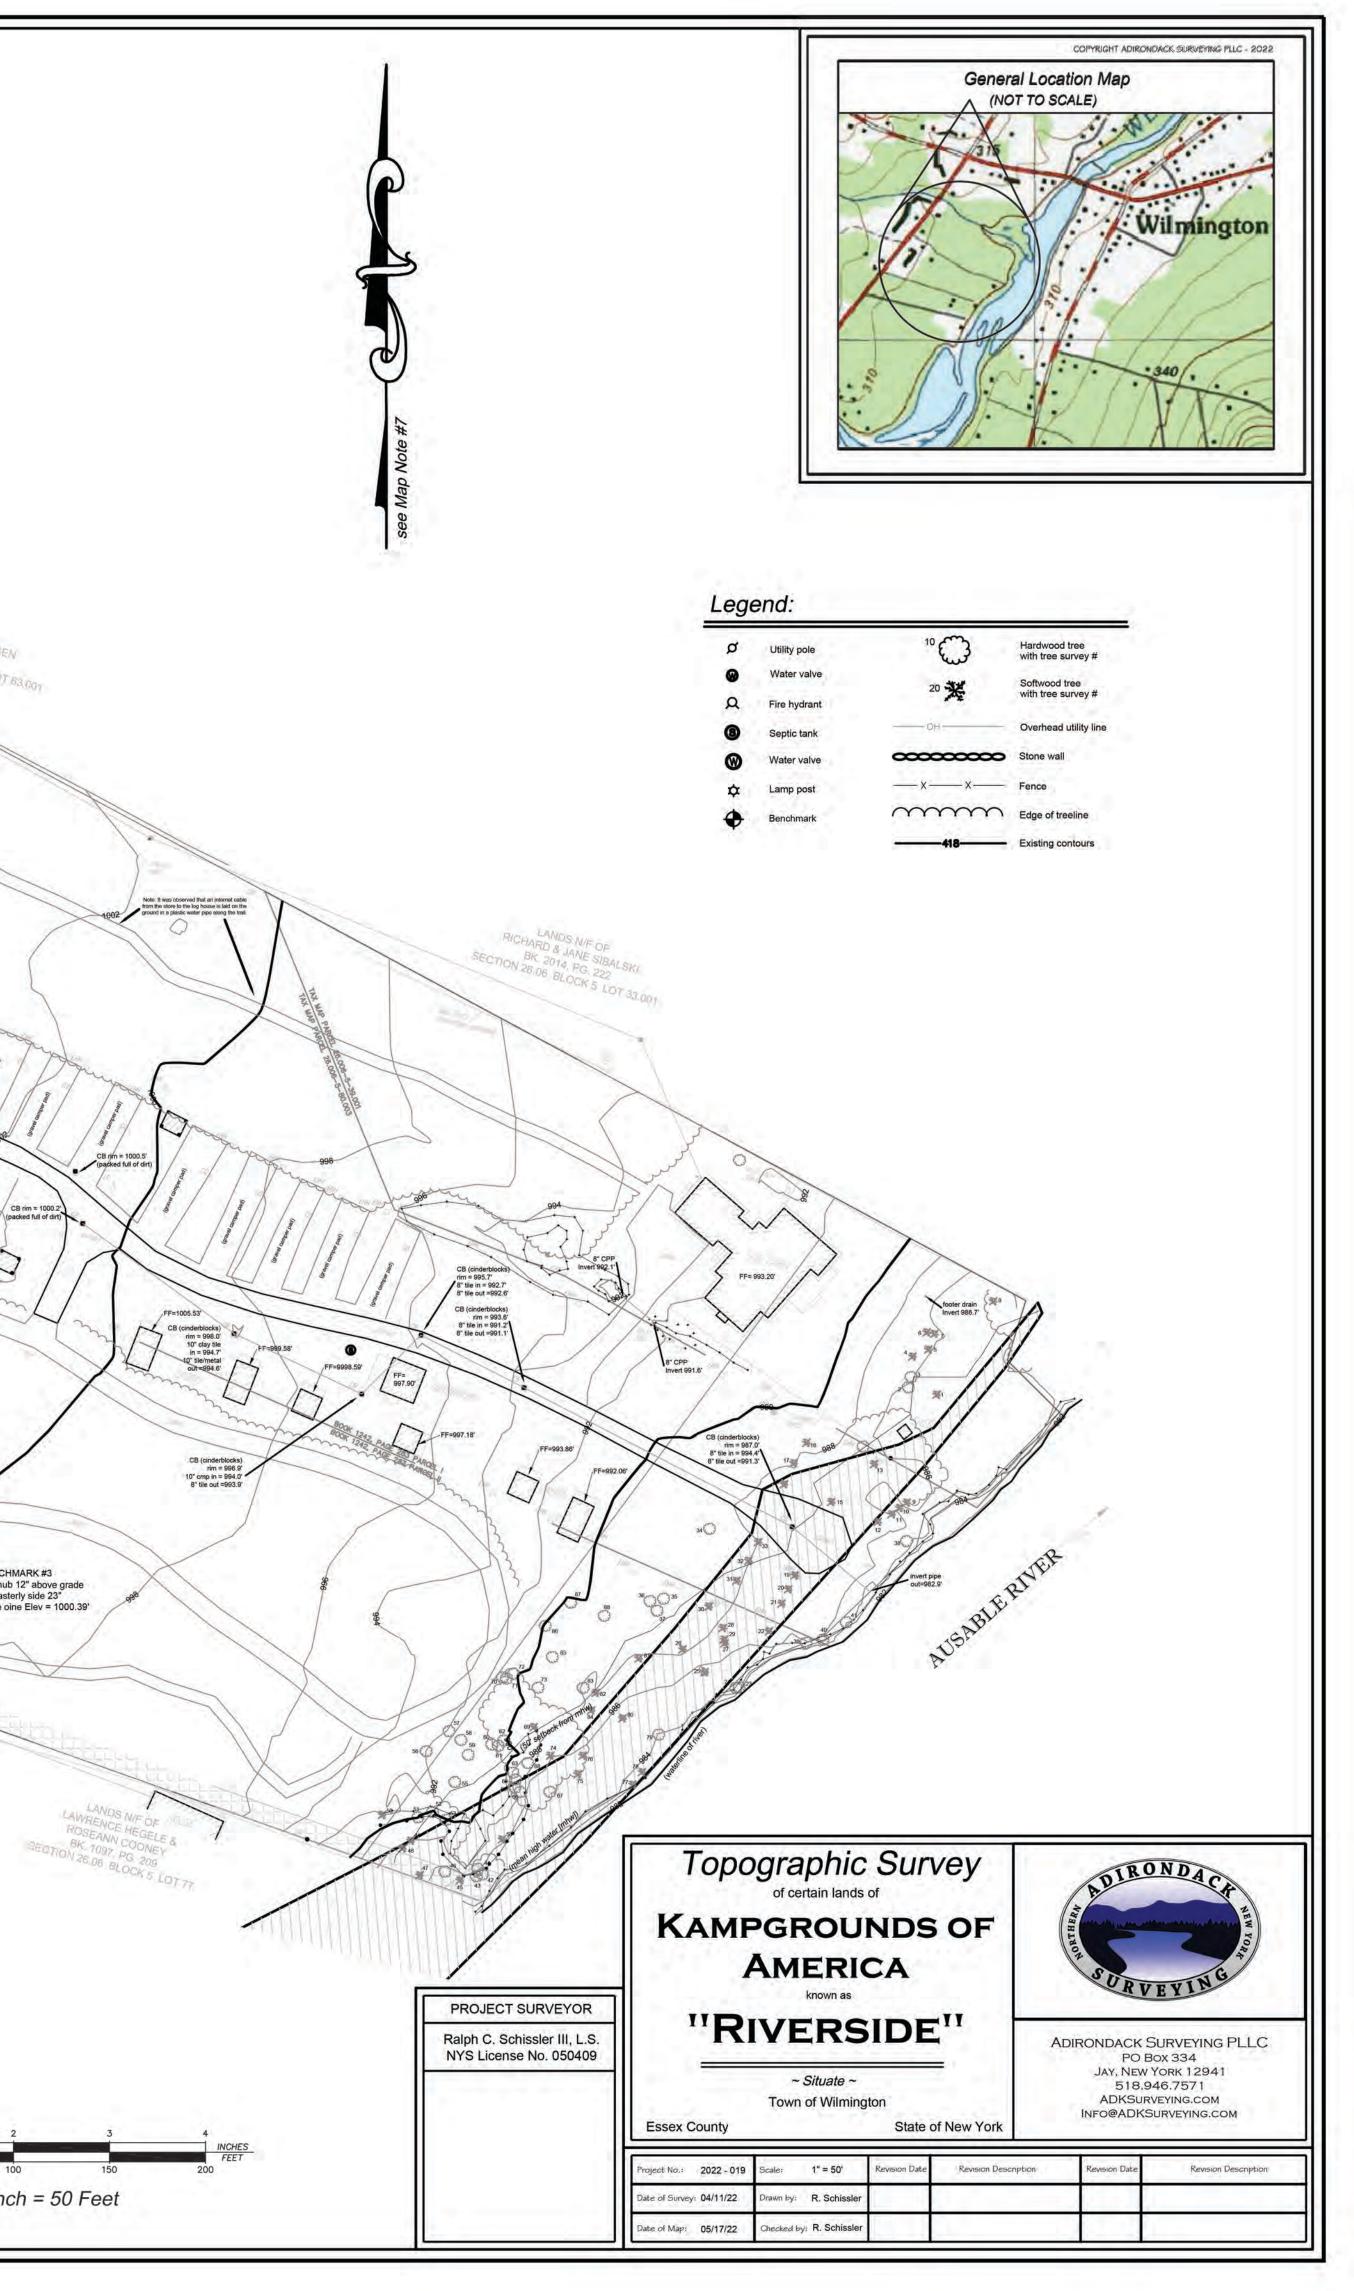

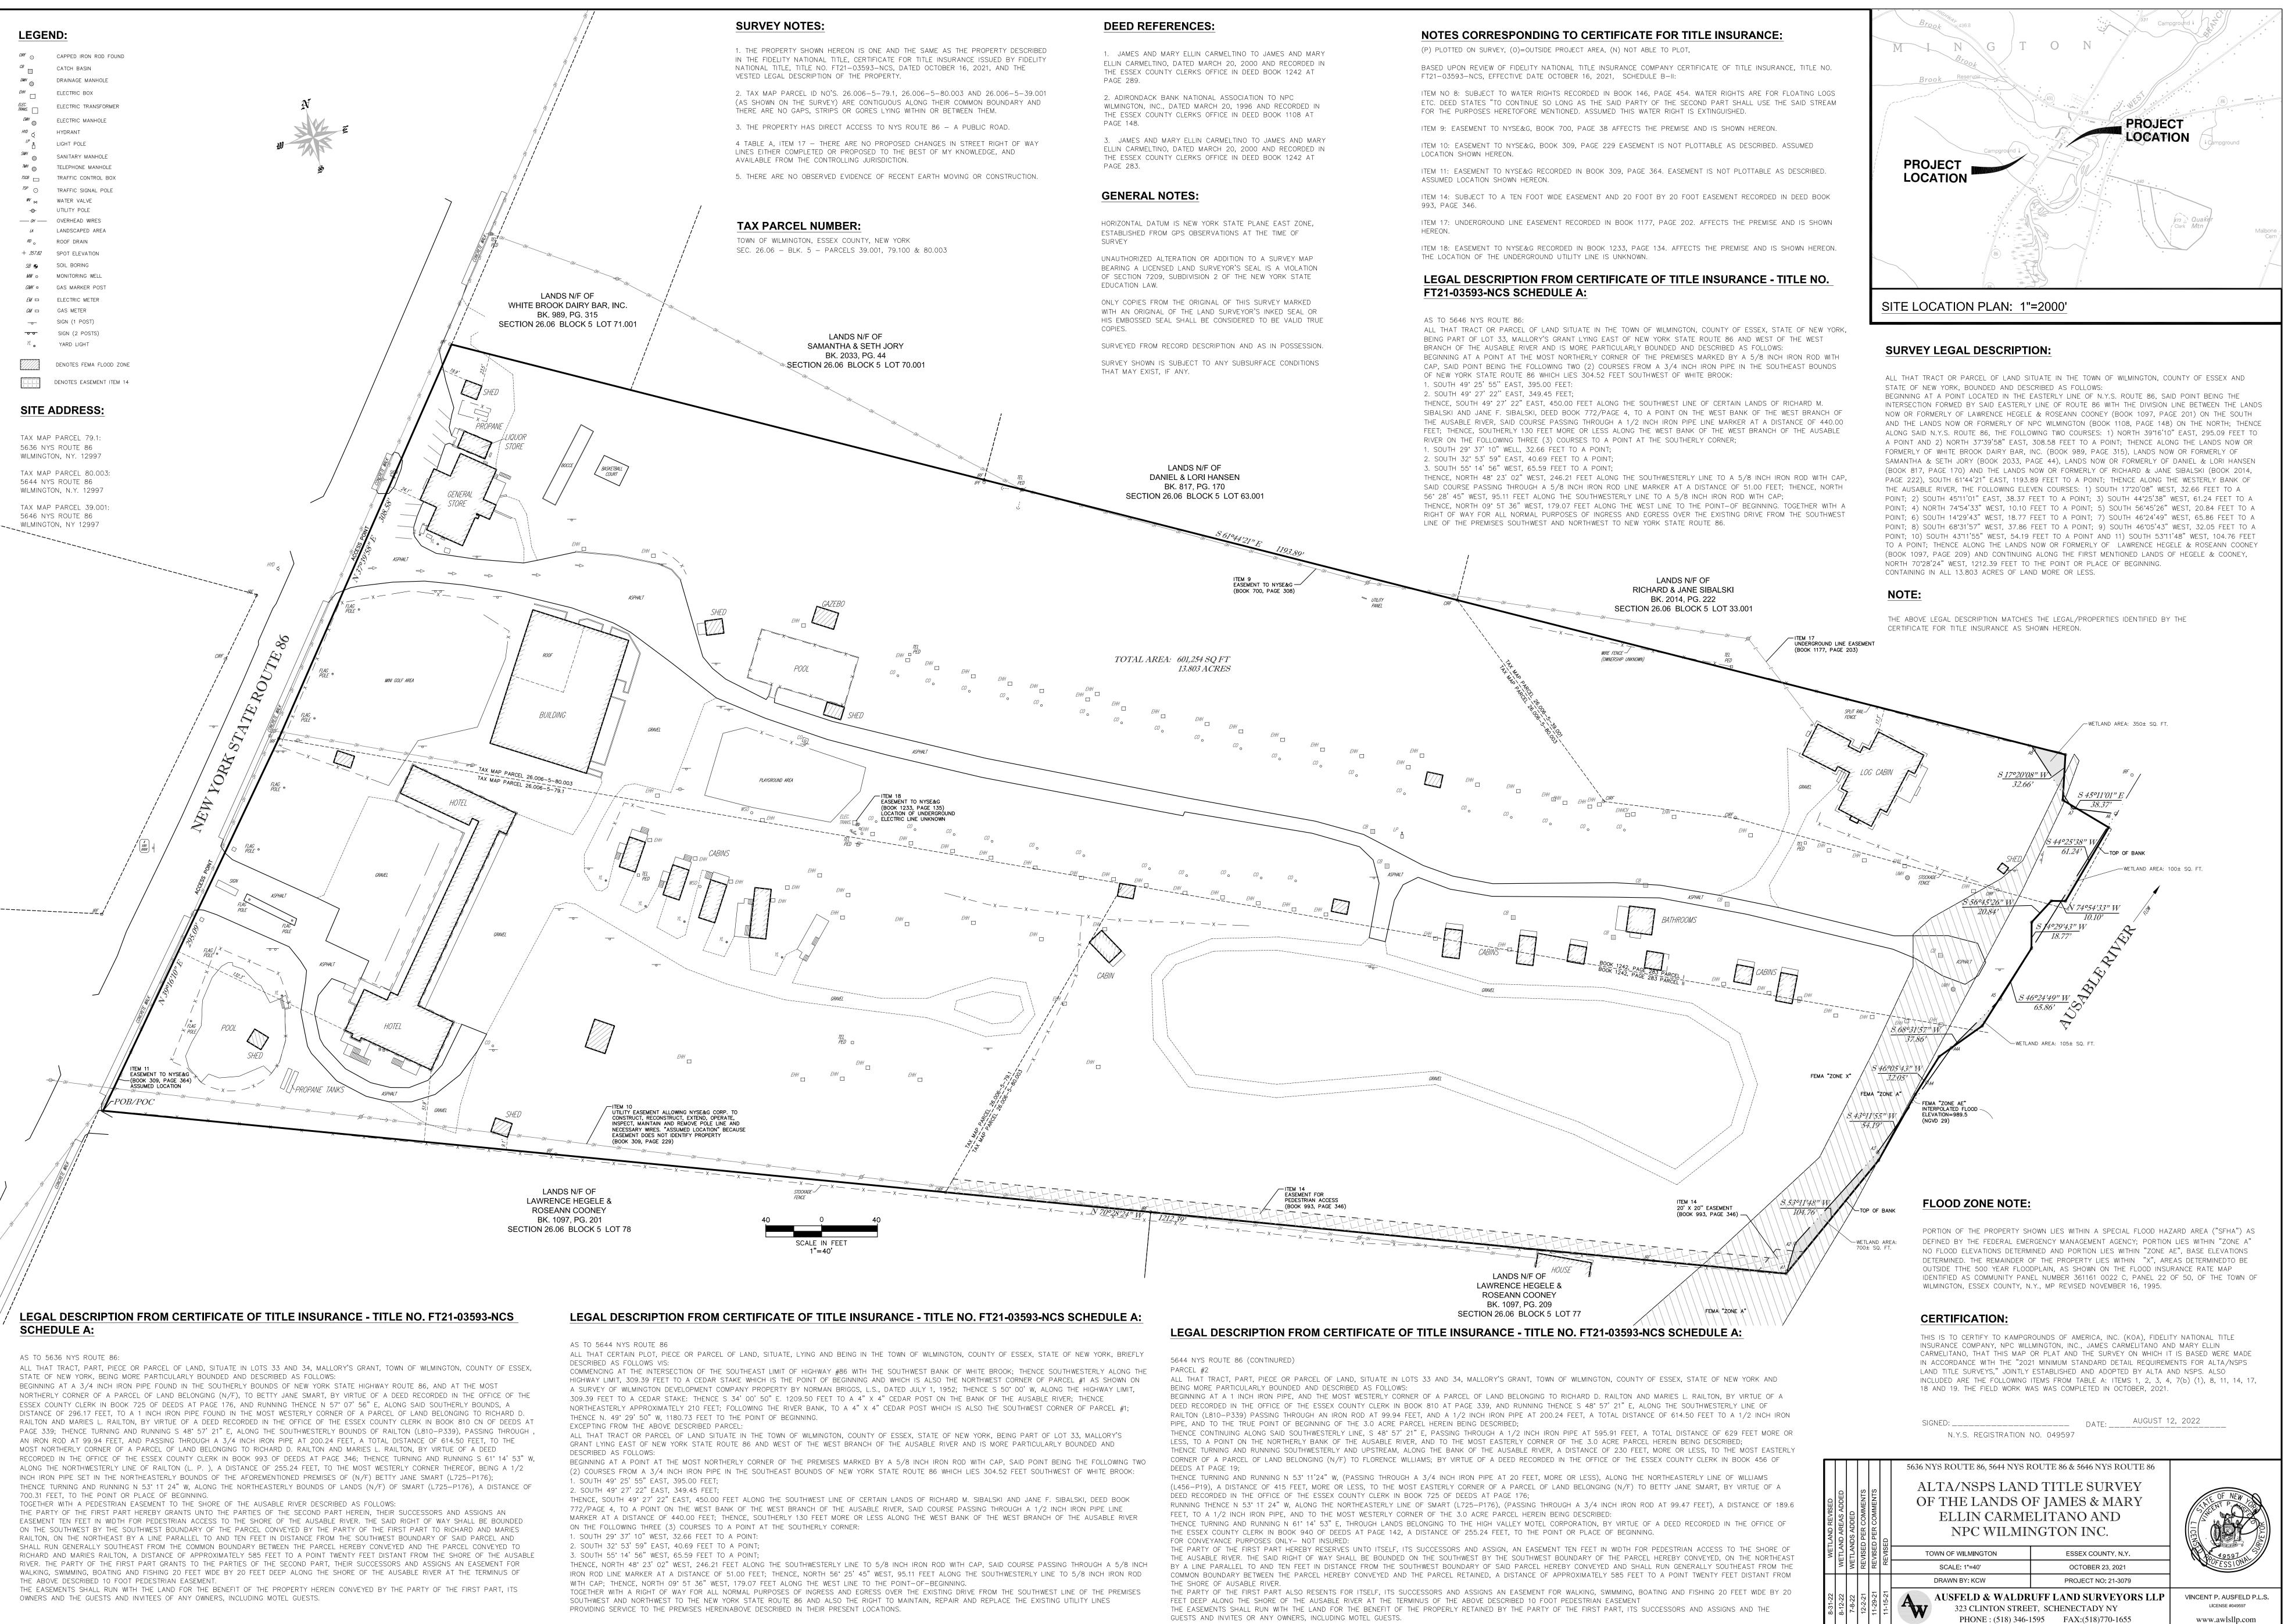

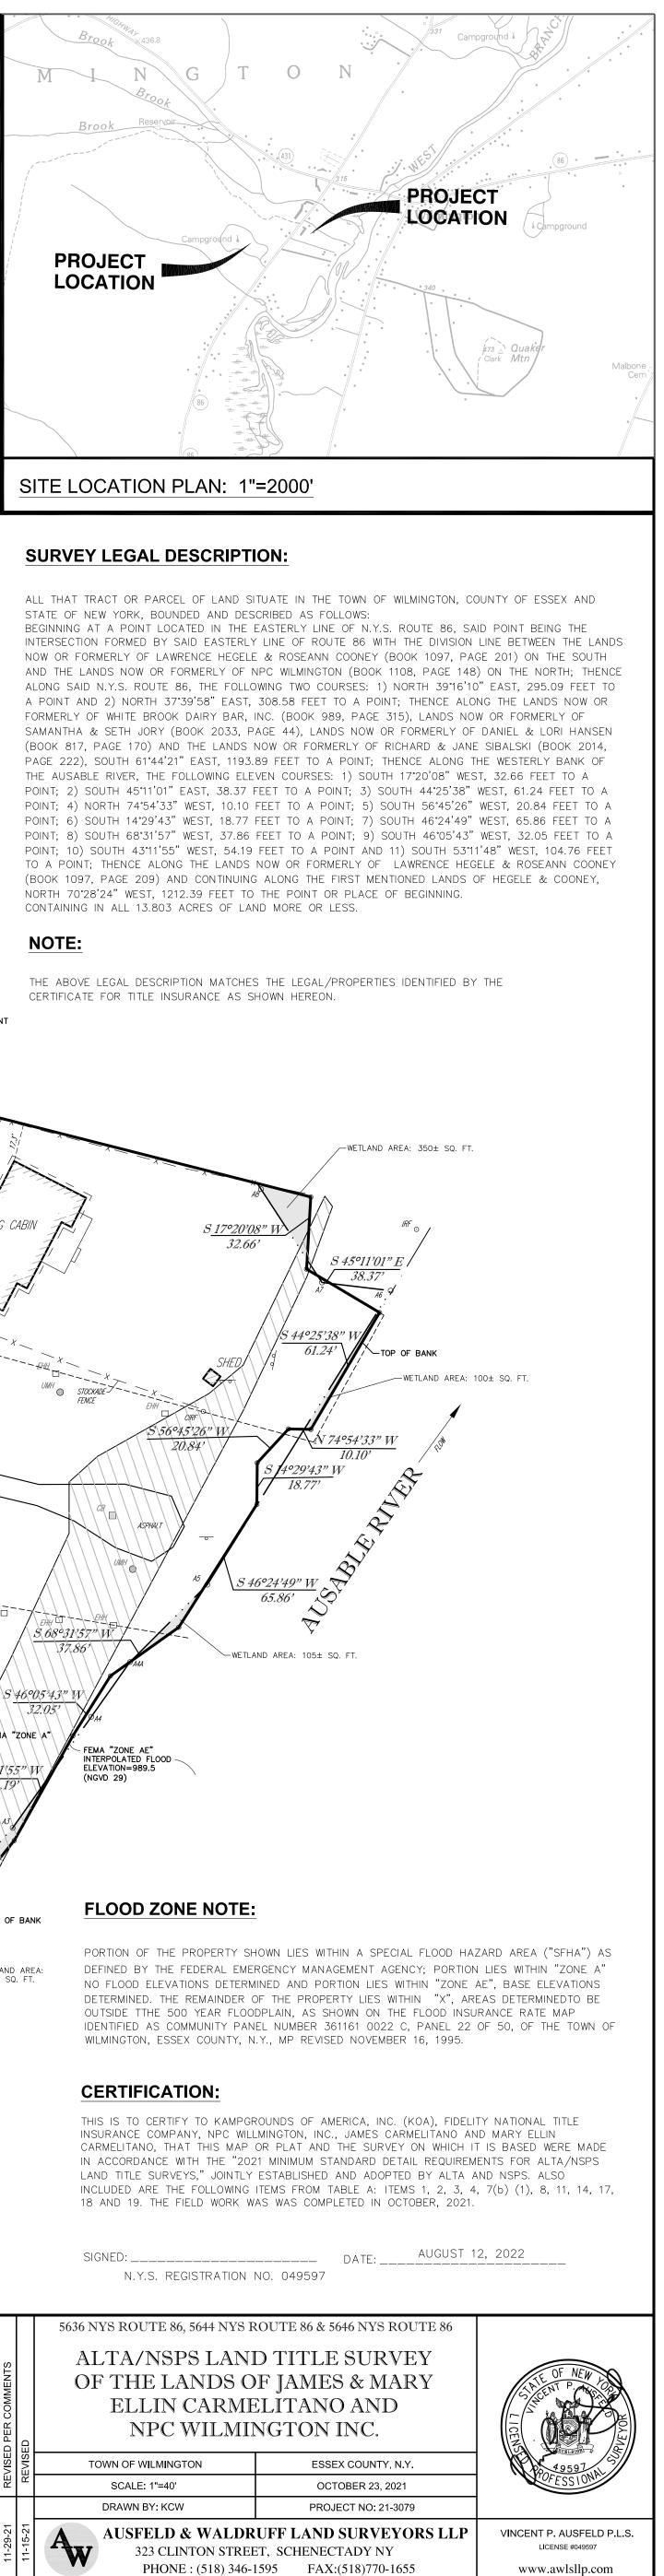

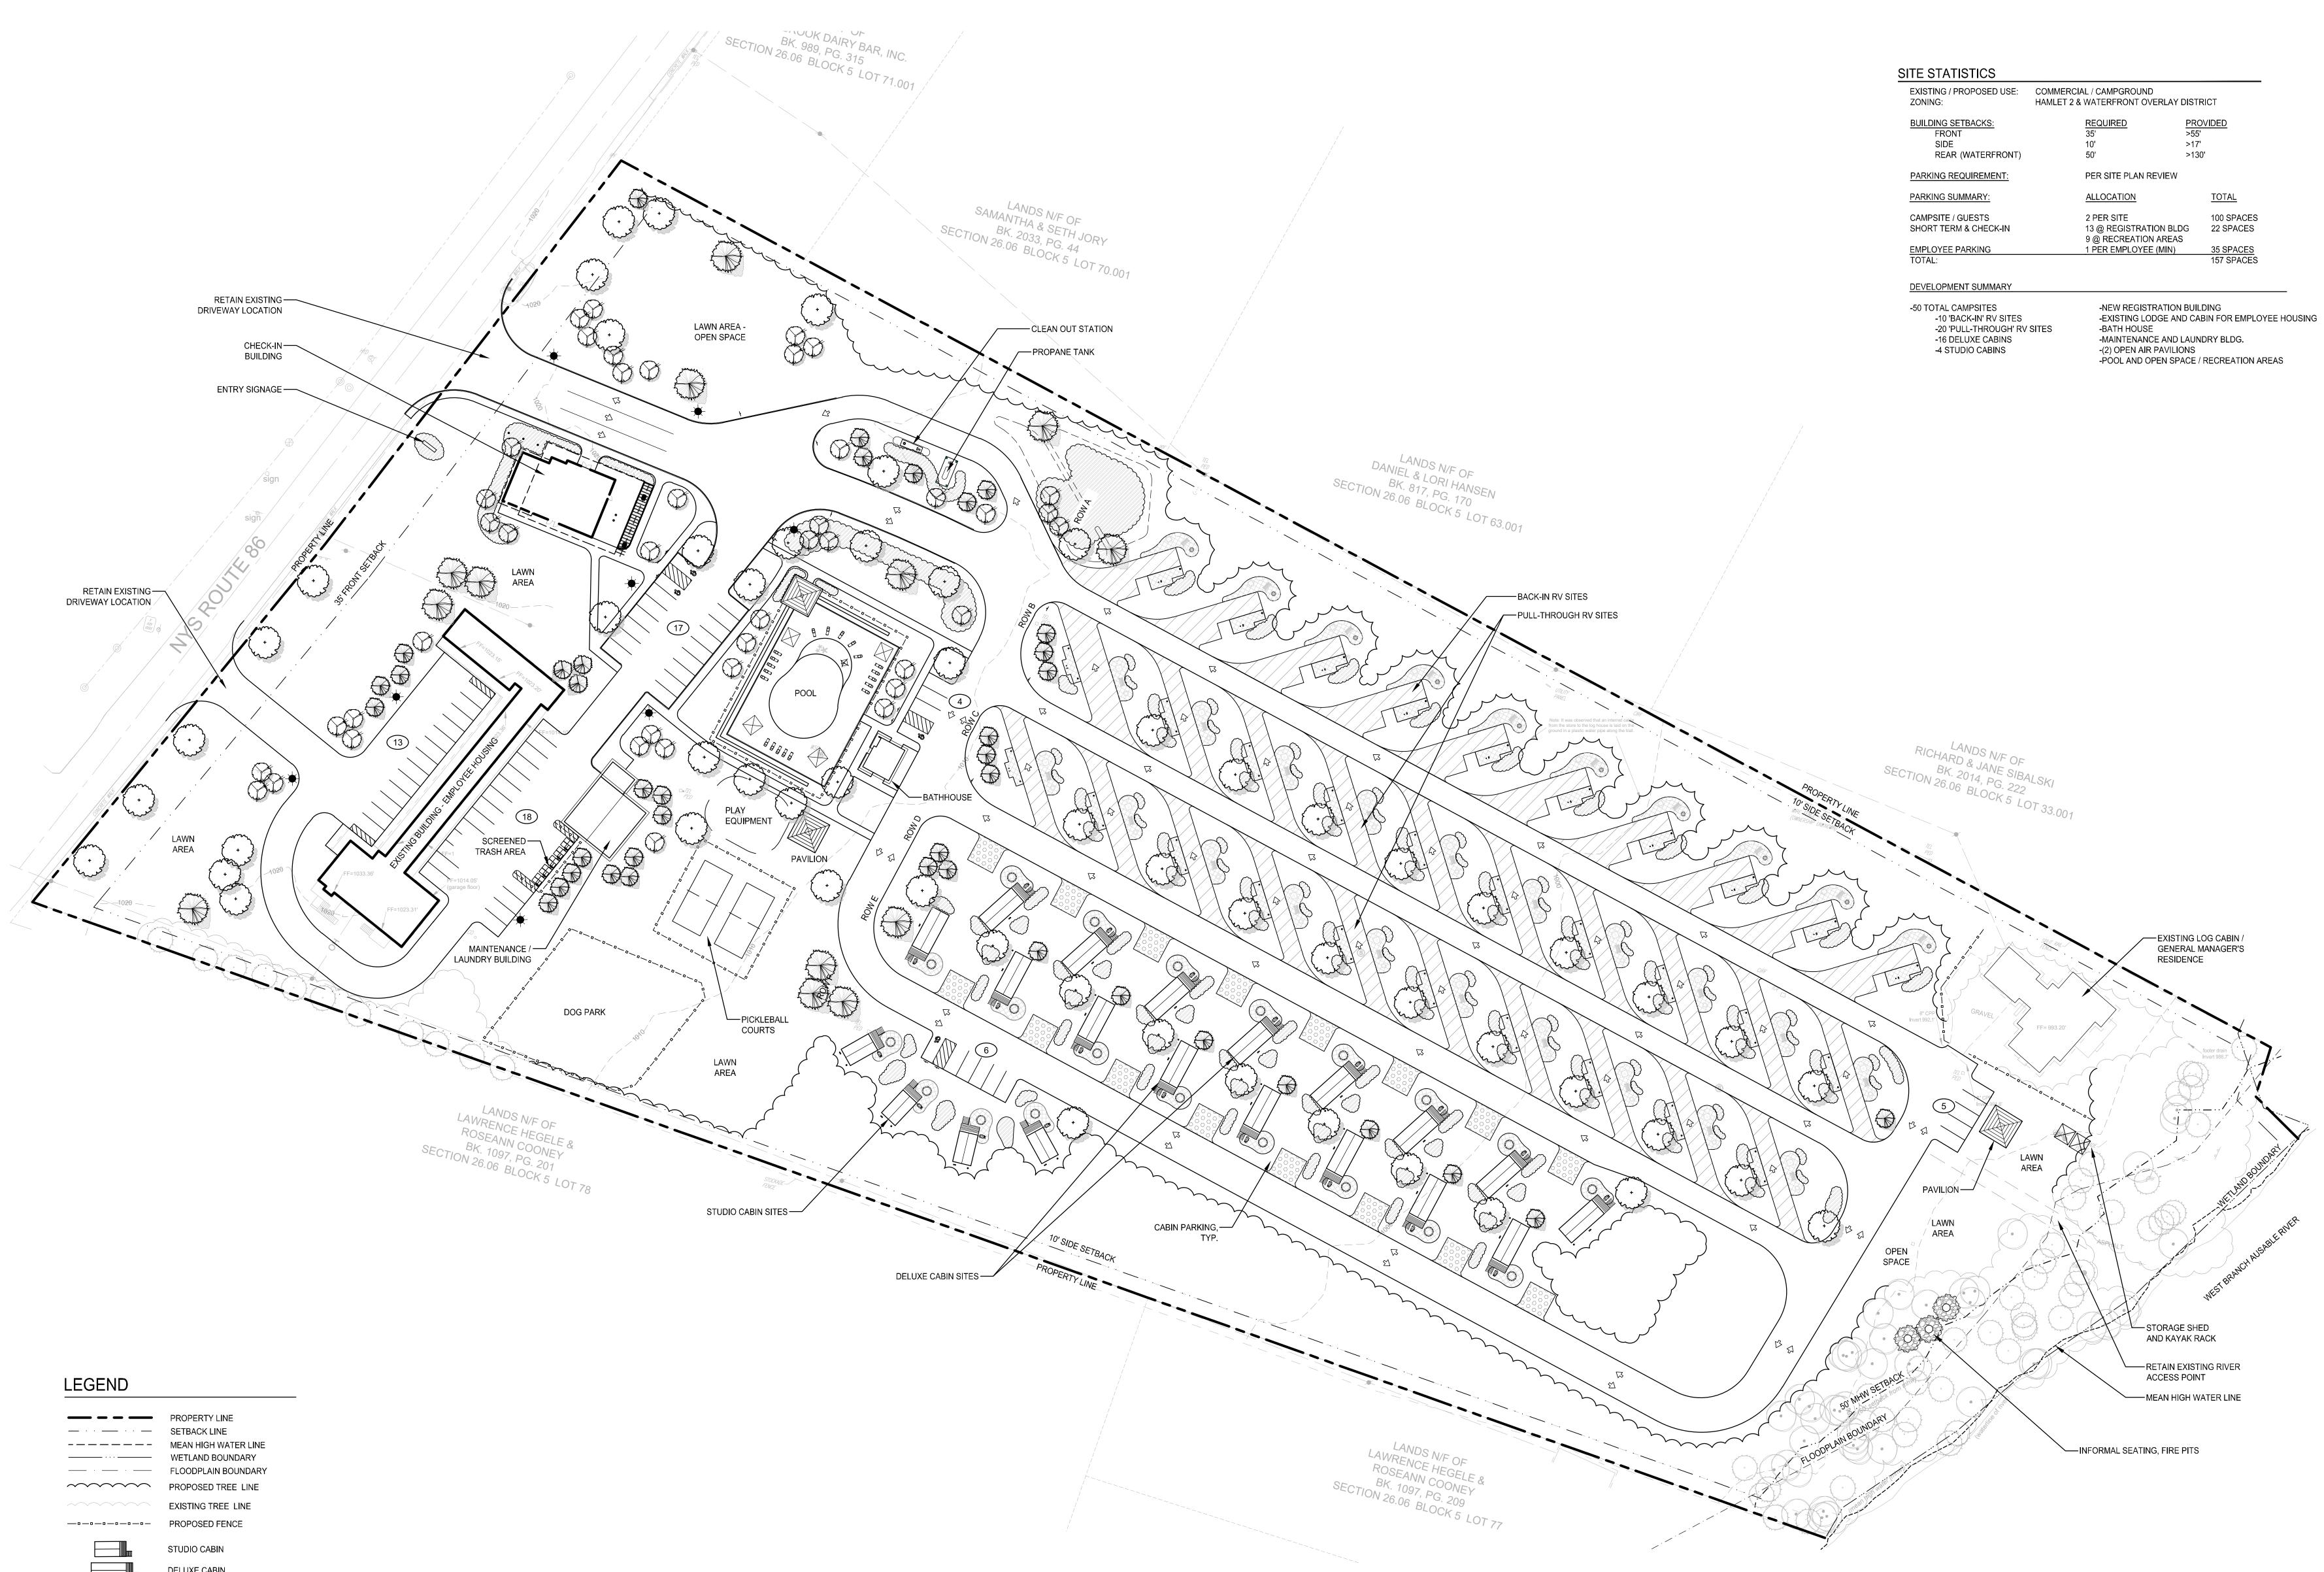

000 A.


(• *J*.


DELUXE CABIN PARKING COUNT


PROPOSED TREES

EXISTING TREES

Plotted By: M/ Save Date: 9/1 File Name: G:[\]

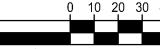

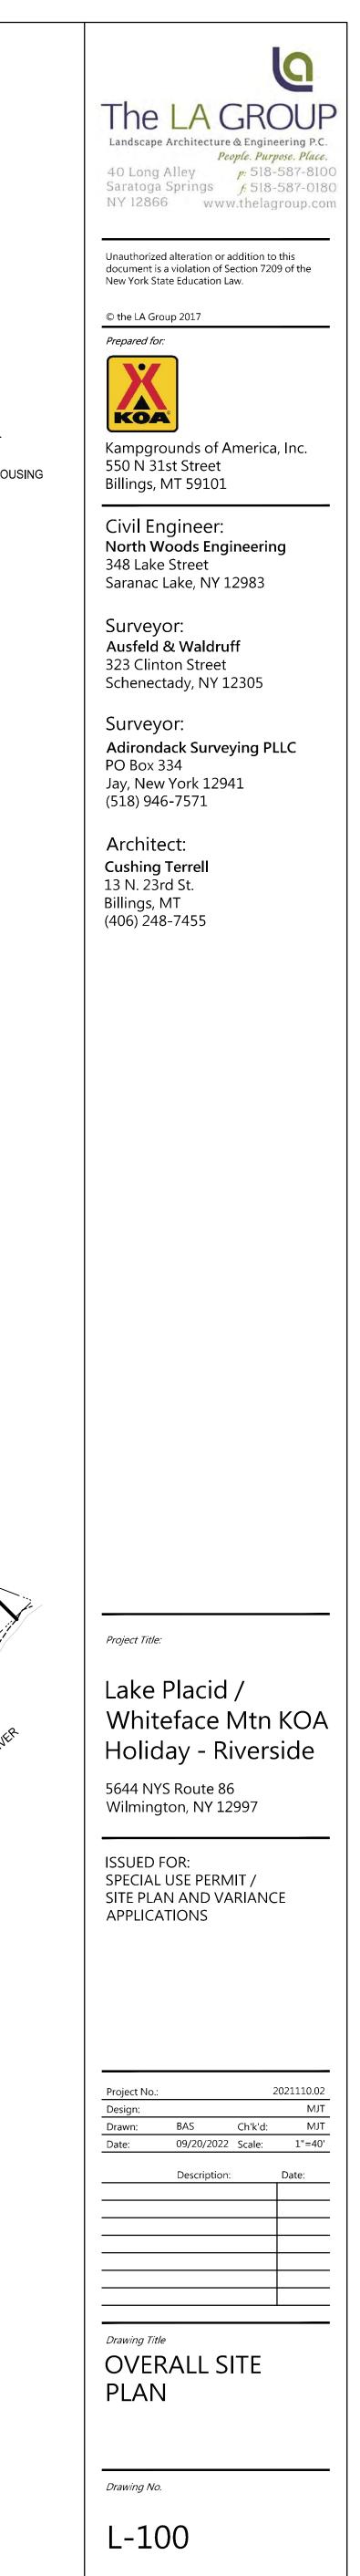

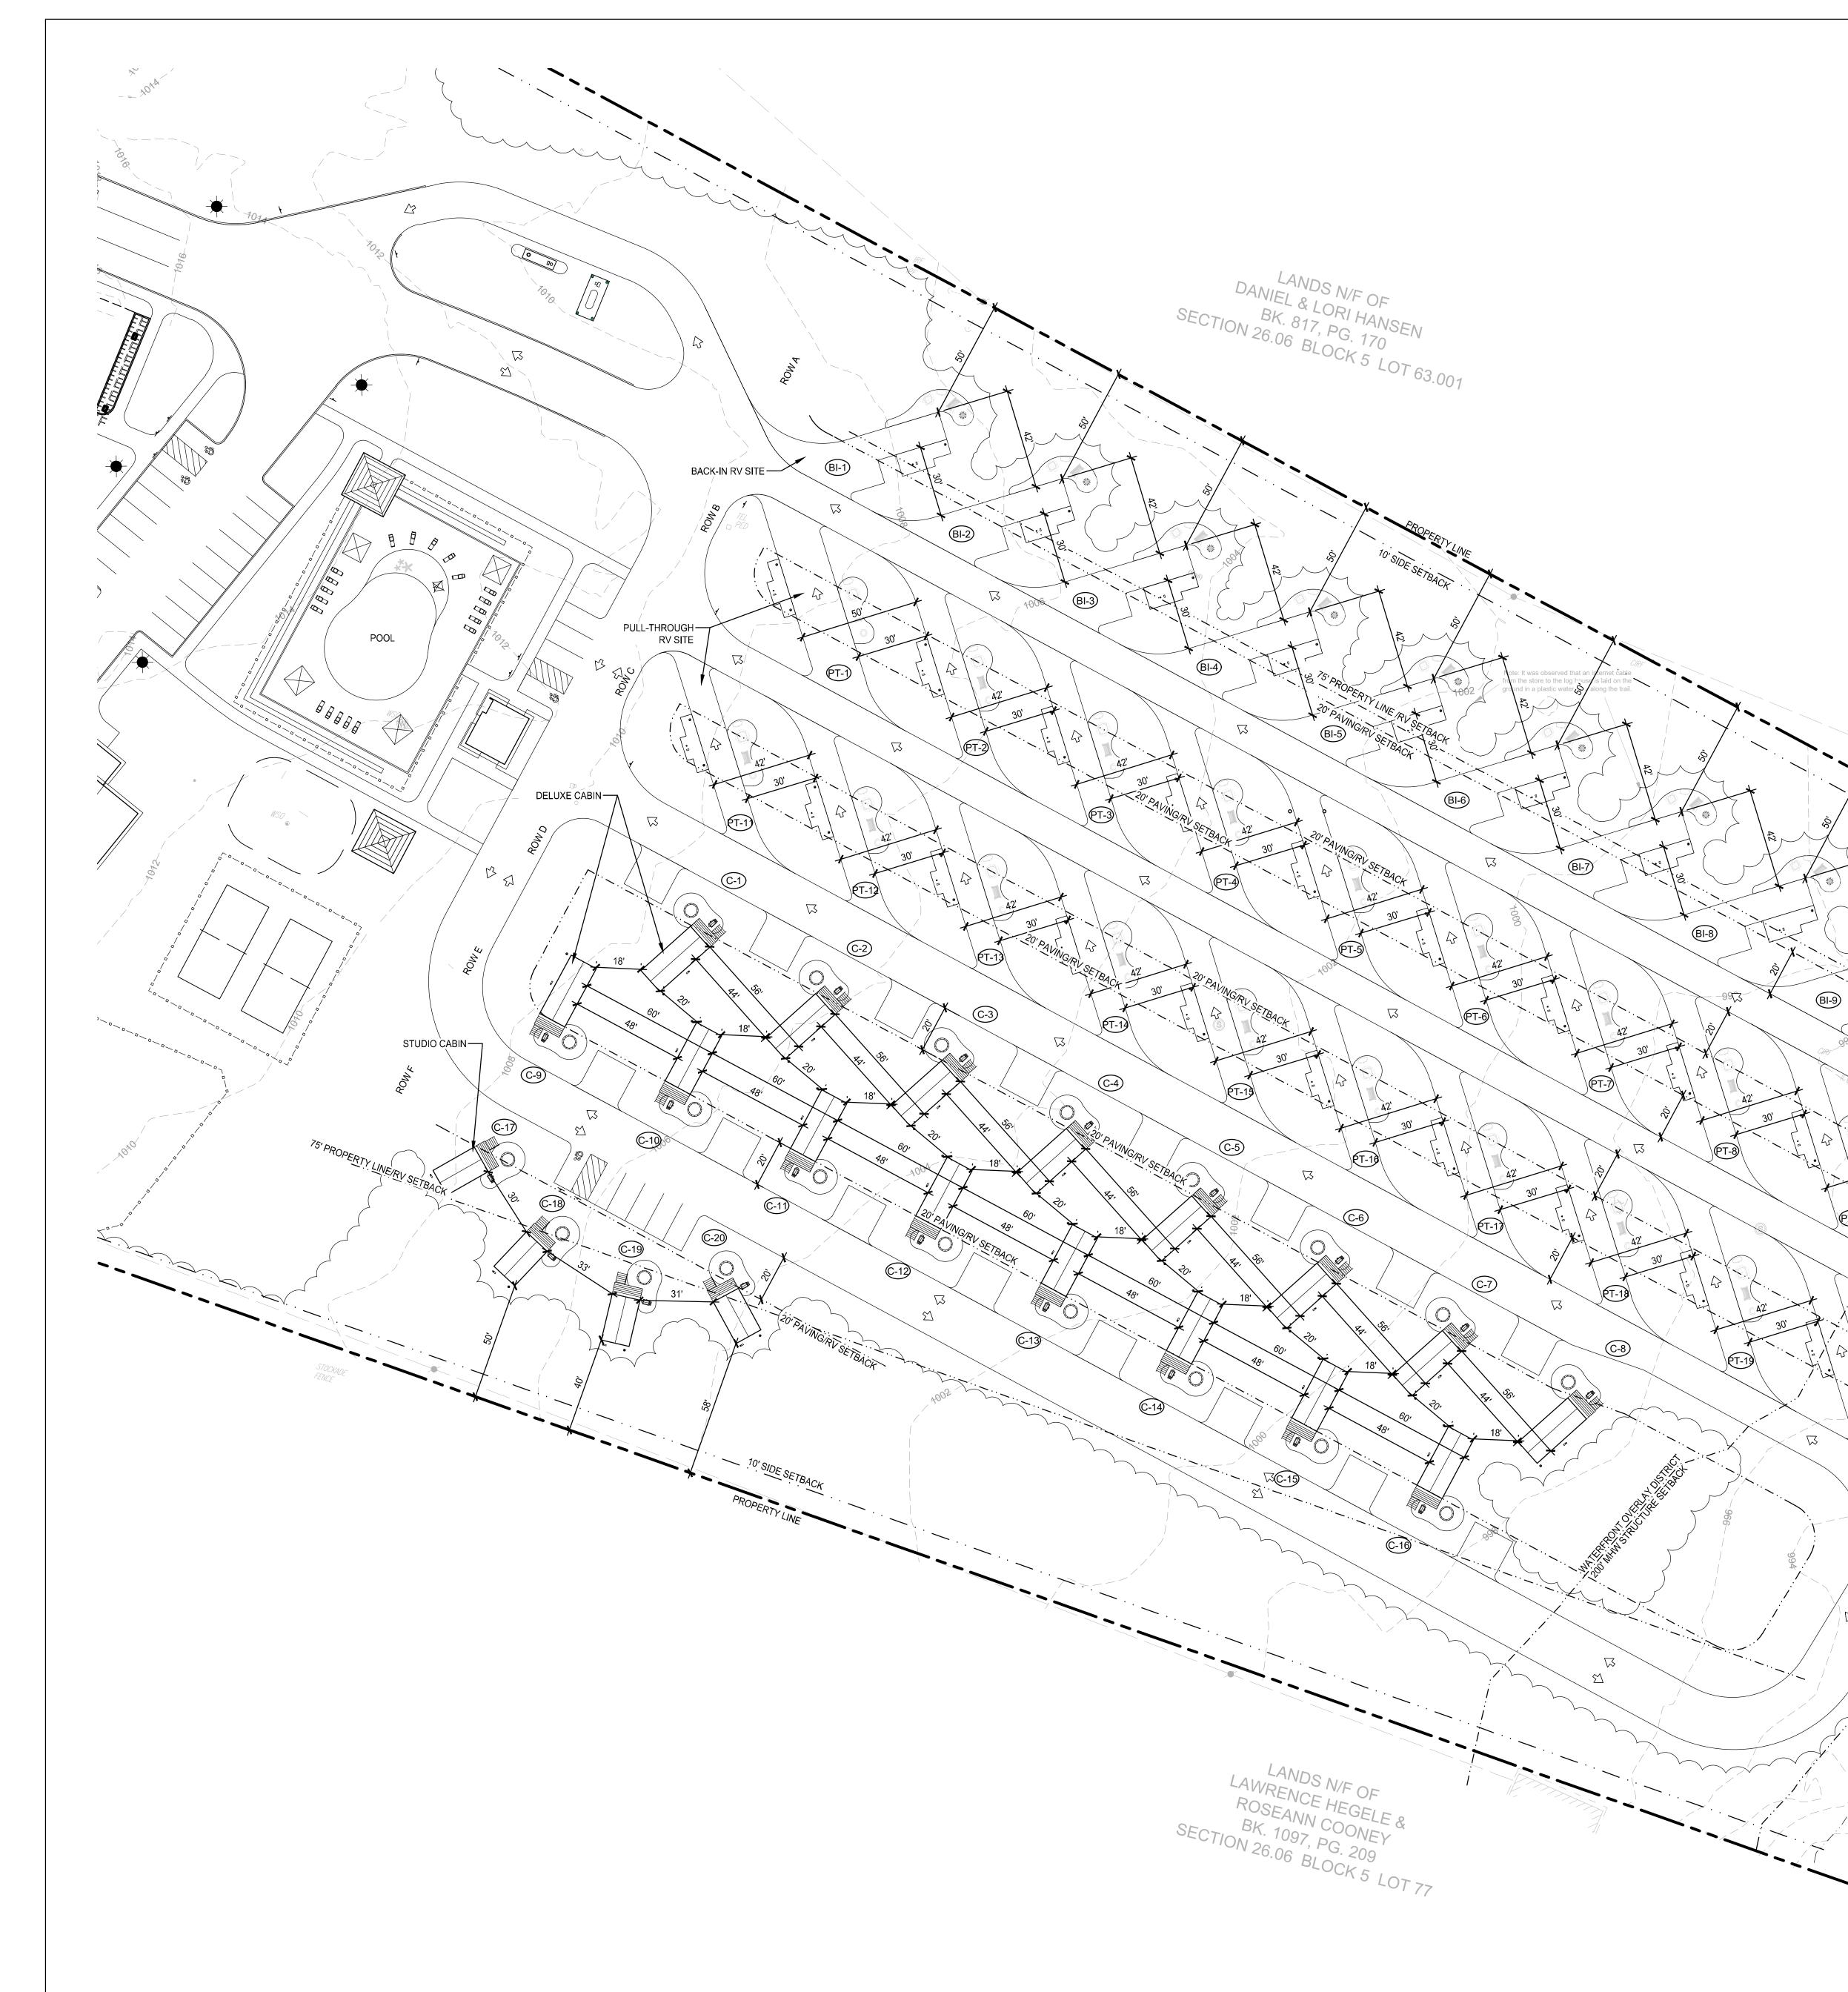

			VAR	ANCES SOL	JGHT (X) AND 75 Feet to	AMOUNTS	(ft.) OF RE		FOR	
		75 Feet to			Adjacent			75 Feet to		
low	Unit	Property Line	Proposed Distance	Variance Sought	Side Units ²	Proposed Distance	Variance Sought	Adjacent Rear Units	Proposed Distance	Vari Sou
А	BI-1	х	50	25	х	42	33			
А	BI-2	Х	50	25	Х	42,42	33,33			
А	BI-3	Х	50	25	Х	42,42	33,33			
А	BI-4	Х	50	25	Х	42,42	33,33			
А	BI-5	Х	50	25	Х	42,42	33,33			
А	BI-6	Х	50	25	х	42,42	33,33			
А	BI-7	Х	50	25	Х	42,42	33,33			
Α	BI-8	X	50	25	Х	42,42	33,33			
Α	BI-9	X	50	25	Х	42,42	33,33			
A	BI-10	X	50	25	Х	42	33			
В	PT-1	-			Х	50	25		-	
B	PT-2				X	50,42	25,33			
B	PT-3				Х	42,42	33,33			
В	PT-4				X	42,42	33,33			
В	PT-5				X	42,42	33,33			
B	PT-6				X	42,42	33,33			
В	PT-7	n			X	42,42	33,33			
B	PT-8				X	42,42	33,33			
B	PT-9				X	42,42	33,33			
B	PT-10				X	42	33			
<u>с</u>	PT-11				X	42	33			
<u>с</u>	PT-12		·		X	42,42	33,33		7	
С	PT-13	-			X	42,42	33,33		-	
<u>с</u>	PT-14				X	42,42	33,33			
C C	PT-15				X X	42,42	33,33			
C C	PT-16 PT-17				X	42,42	33,33			
c	PT-17 PT-18	-			X	42,42 42,42	33,33 33,33			
<u>с</u>	PT-19				X	42,42	33,33			
c	PT-20				X	42,42	33			
D	C-1				X	56	19	х	19,20	56
D	C-2				X	56,56	19,19	X	19,20	56
D	C-3				X	56,56	19,19	x	19,20	56
D	C-4				x	56,56	19,19	x	19,20	56
D	C-5				x	56,56	19,19	x	19,20	56
D	C-6	-			X	56,56	19,19	X	19,20	56
D	C-7				X	56,56	19,19	X	19,20	56
D	C-8		· · · · · · · · · · · · · · · · · · ·		x	56	19	x	19	5
E	C-9				x	60	15	X	19	5
E	C-10				X	60,60	15,15	X	19,20	56
E	C-11				Х	60,60	15,15	Х	19,20	56
E	C-12				х	60,60	15,15	Х	19,20	56
E	C-13				х	60,60	15,15	Х	19,20	56
E	C-14				Х	60,60	15,15	Х	19,20	56
E	C-15				х	60,60	15,15	Х	19,20	56
Е	C-16				х	60	15	Х	19,20	56
F	C-17				х	30	45			
F	C-18	Х	50	25	х	30,33	45,42			· ····
	C-19	Х	40	35	х	33,31	42,44			
F	C-20	Х	58	17	Х	31	44			

- 10X10 SHED AND KAYAK RACK

- 20X20 PAVILION

FF= 993.20'

RICHARD & J. LANDS SECTION 26.06 BLC

BI-10





----- MEAN HIGH WATER LINE


TREE LINE STUDIO CABIN


DELUXE CABIN



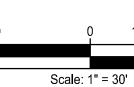

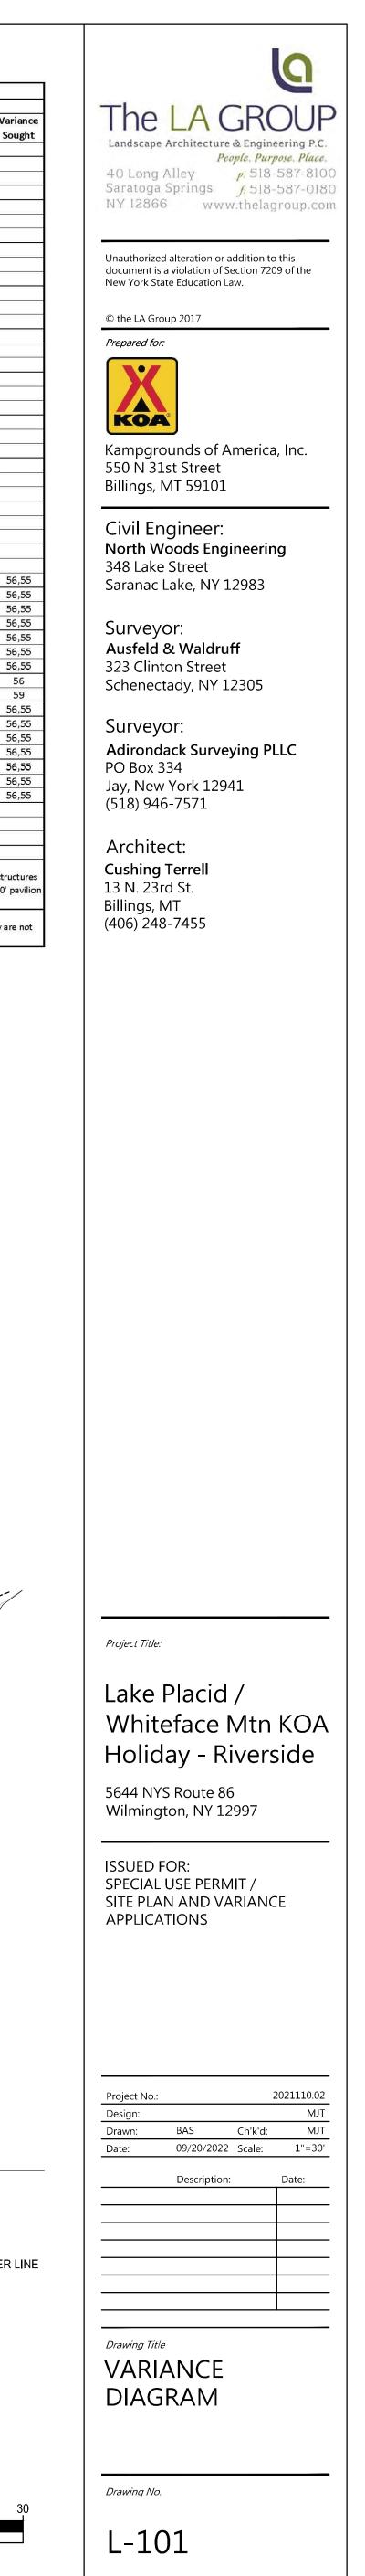

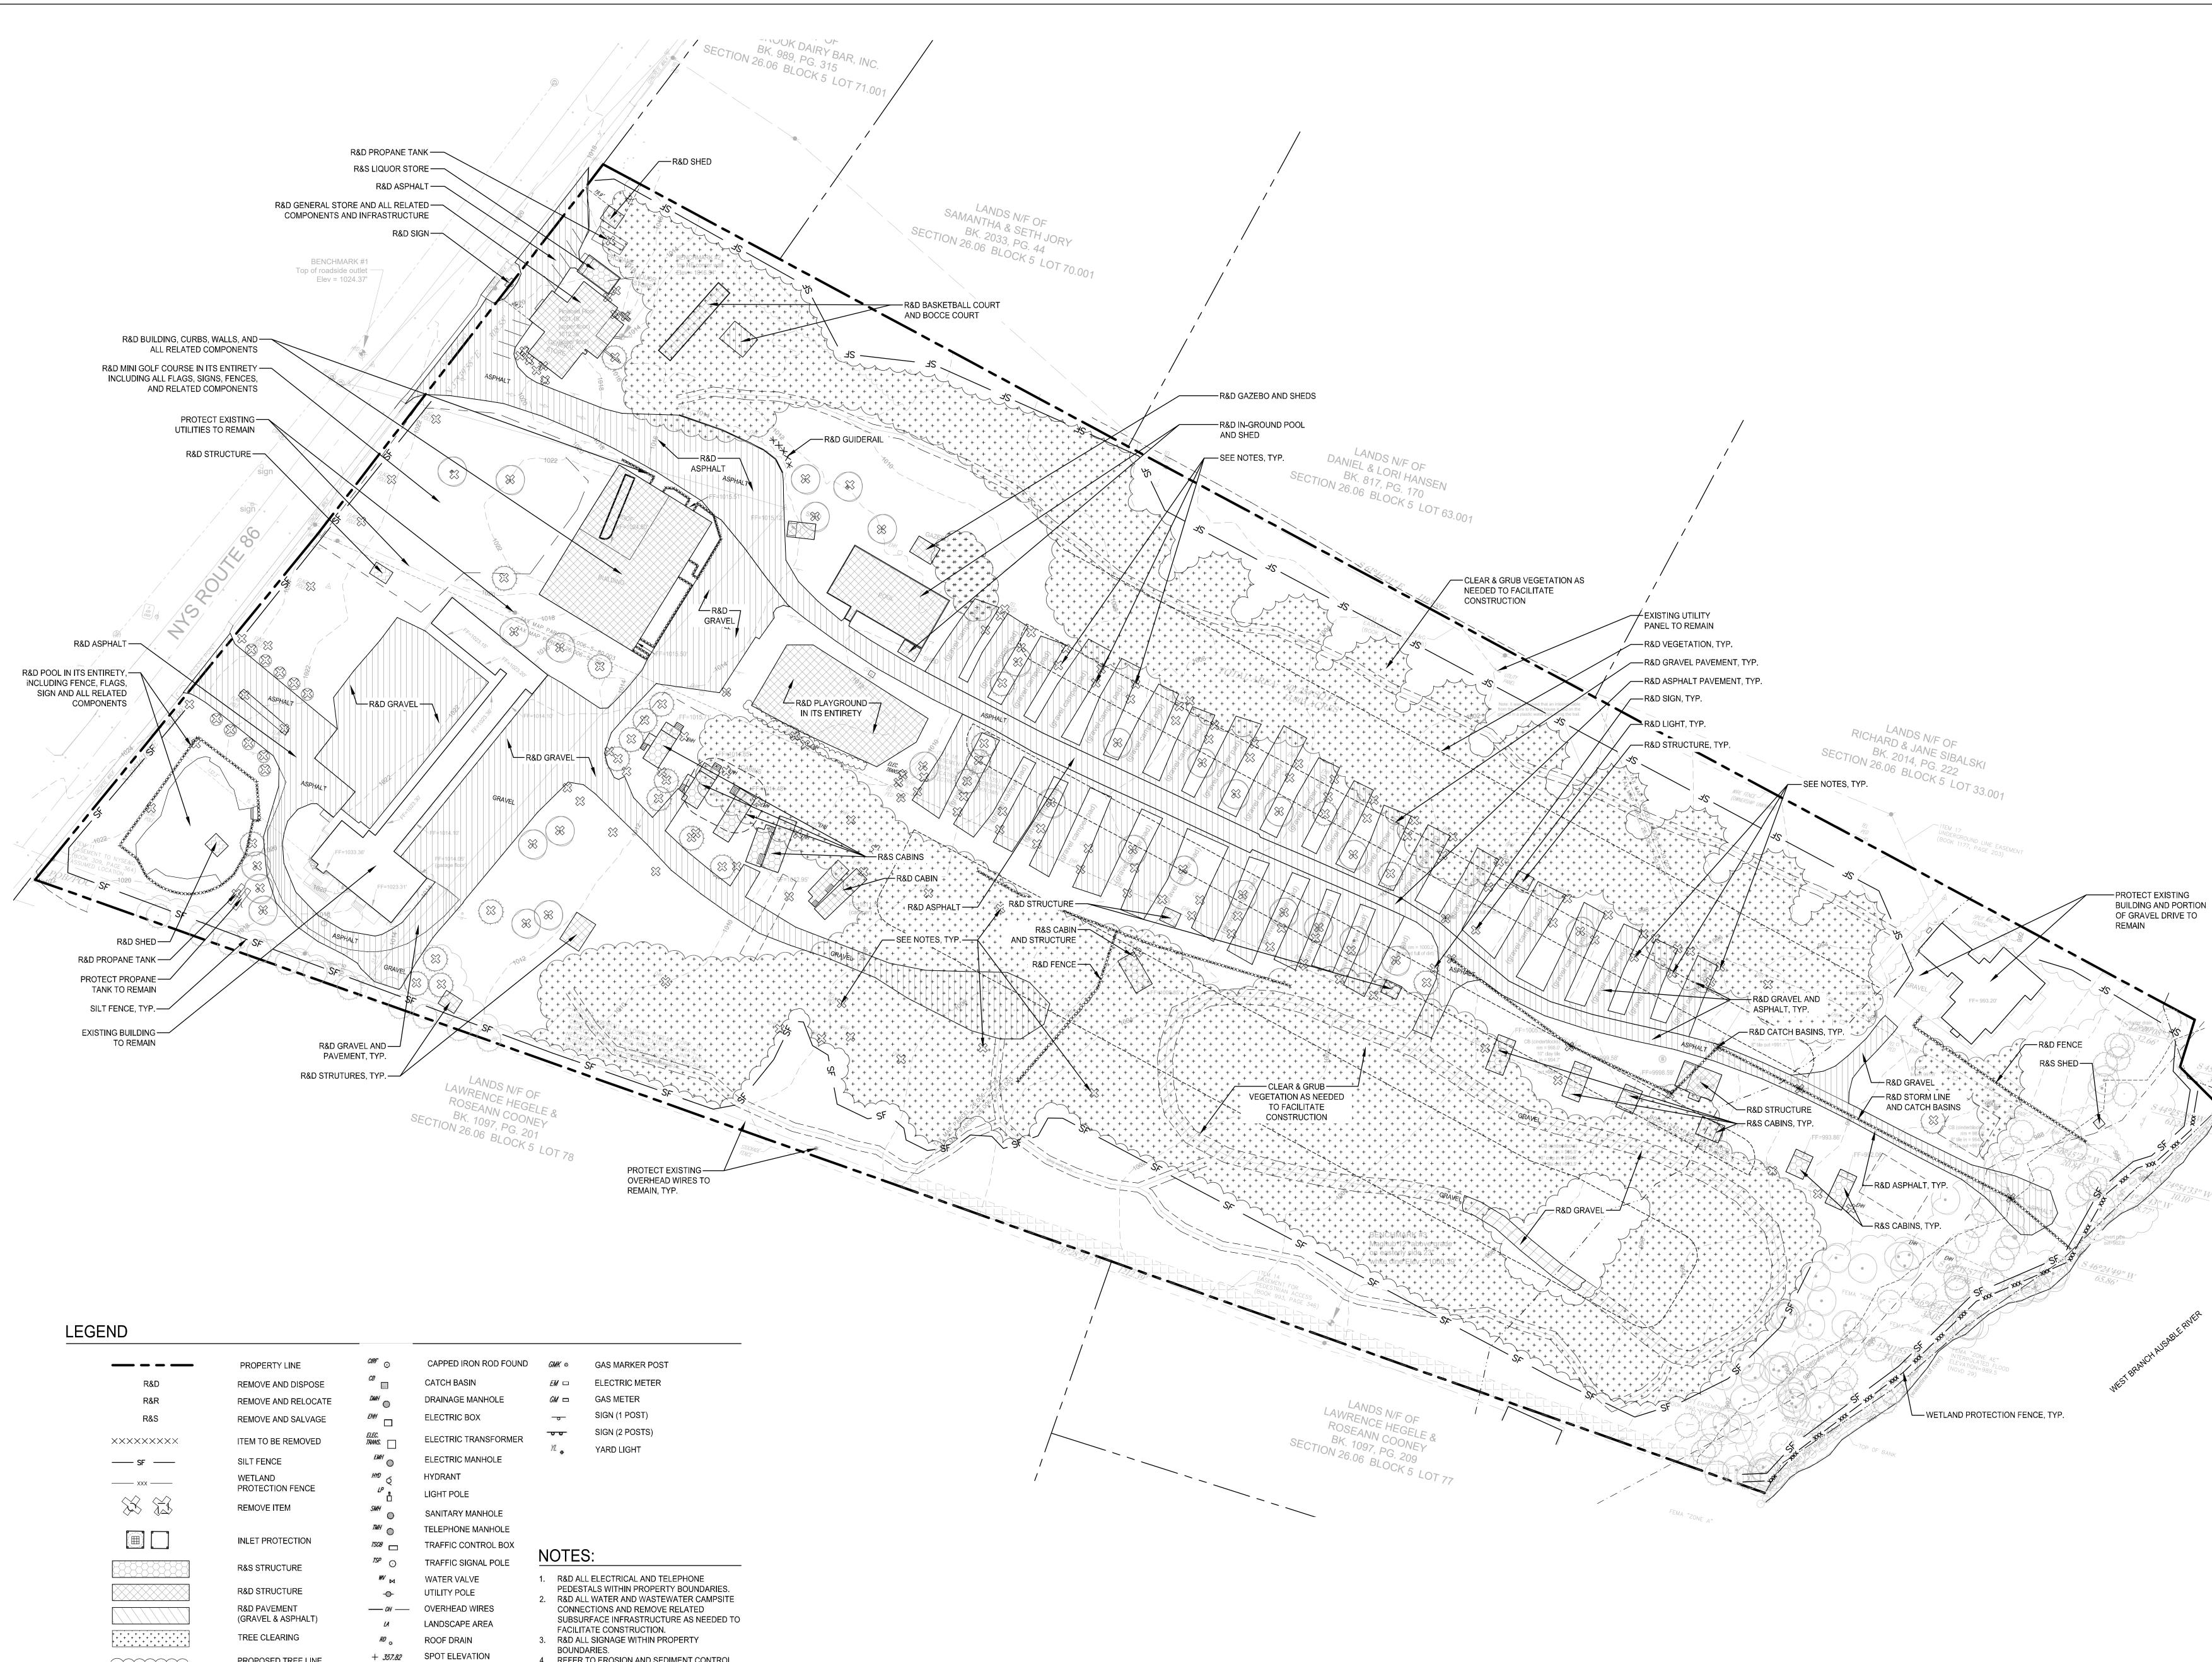

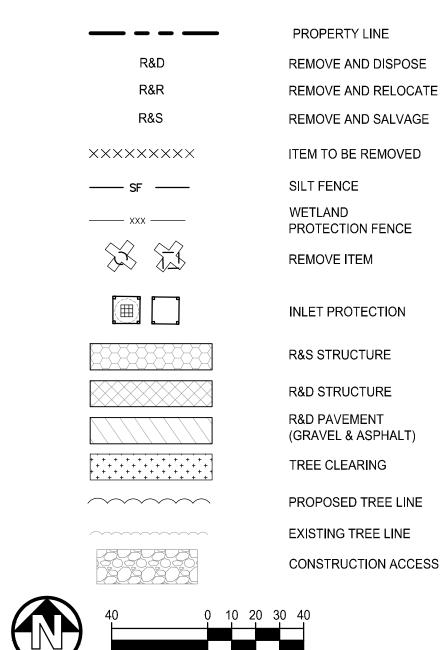



SB 🕒 SOIL BORING

CATCH BASIN
DRAINAGE MANHOLE
ELECTRIC BOX
ELECTRIC TRANSFORMER
ELECTRIC MANHOLE
HYDRANT
LIGHT POLE
SANITARY MANHOLE
TELEPHONE MANHOLE
TRAFFIC CONTROL BOX
TRAFFIC SIGNAL POLE
WATER VALVE
UTILITY POLE
OVERHEAD WIRES
LANDSCAPE AREA

GAS MARKER POST
ELECTRIC METER
GAS METER
SIGN (1 POST)
SIGN (2 POSTS)
YARD LIGHT

- 4. REFER TO EROSION AND SEDIMENT CONTROL PLAN FOR ADDITIONAL EROSION CONTROL MEASURES.

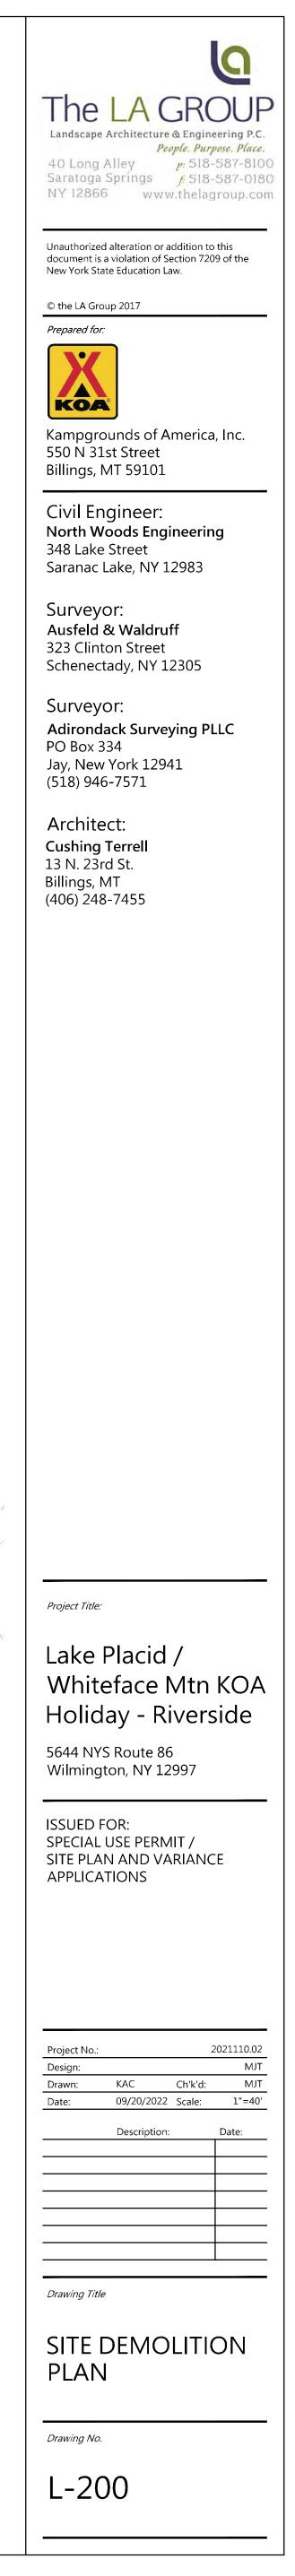


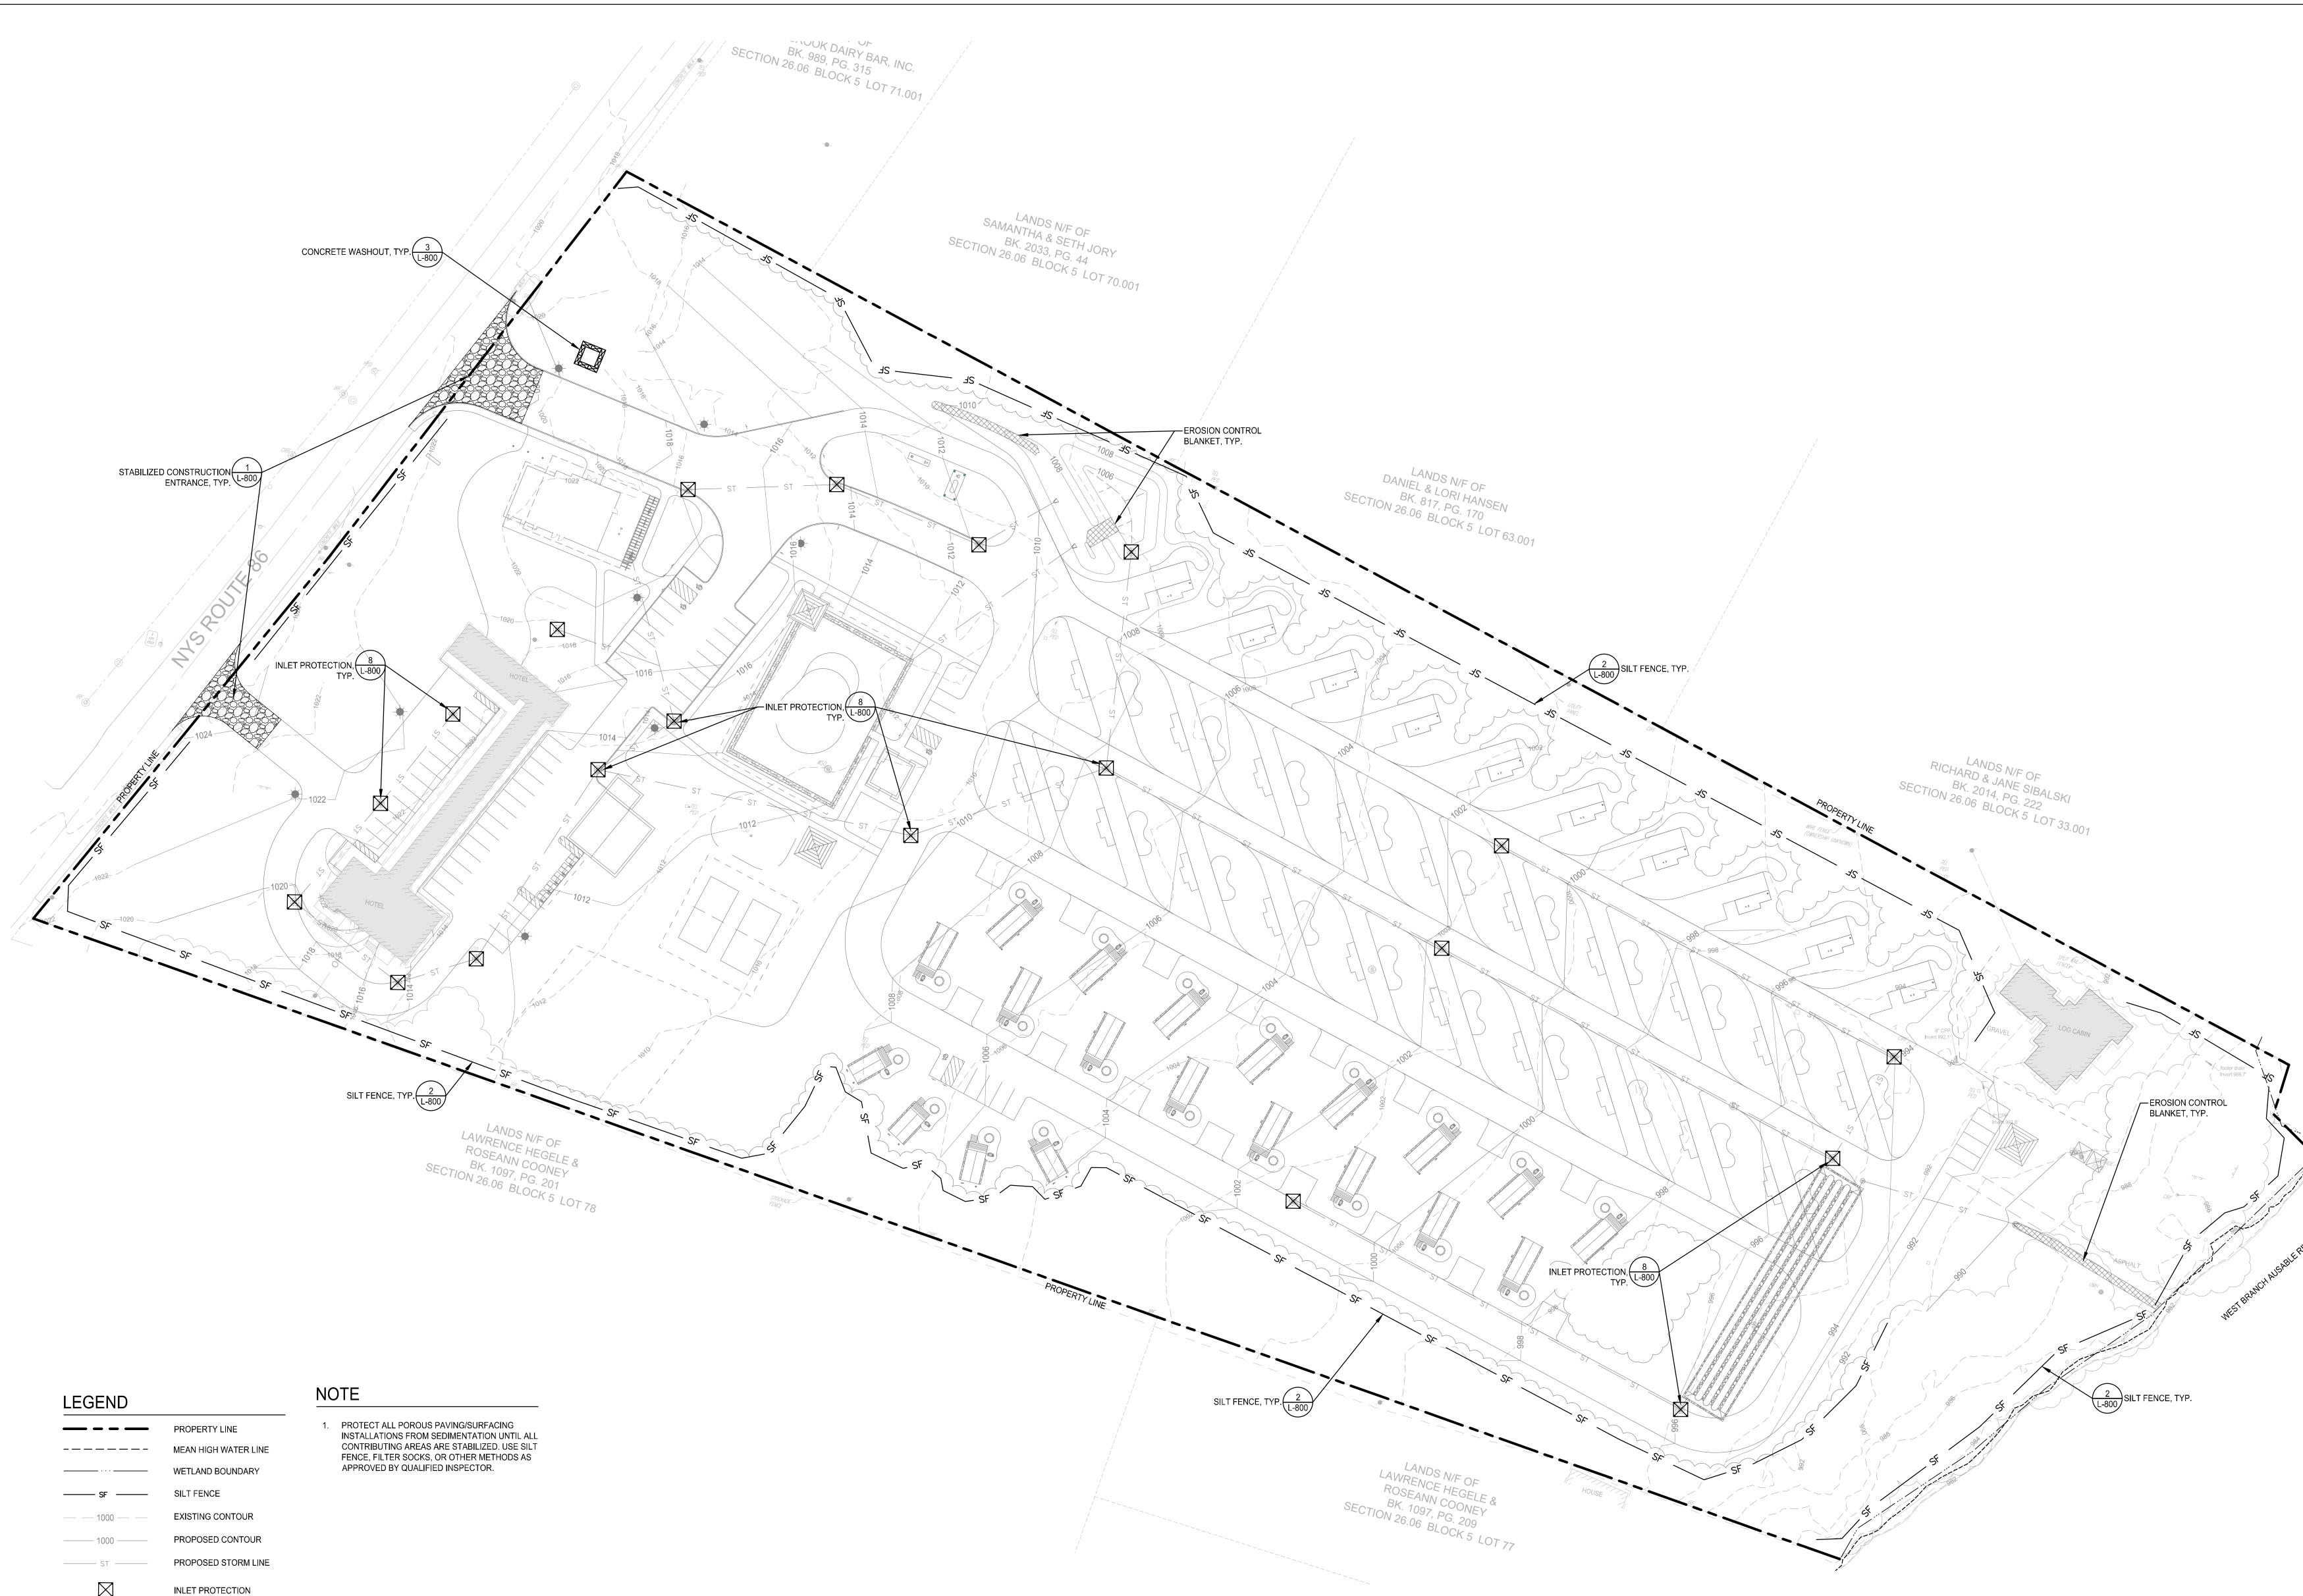



····
SF
— — 1000 — —
1000
ST
\boxtimes
~~~~~~
~~~~~~~~~~~~~~~~~~~~~~~~~~~~~~~~~~~~~~~


PROPOSED TREE LINE

EXISTING TREE LINE CONSTRUCTION ACCESS

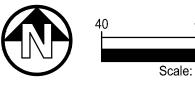


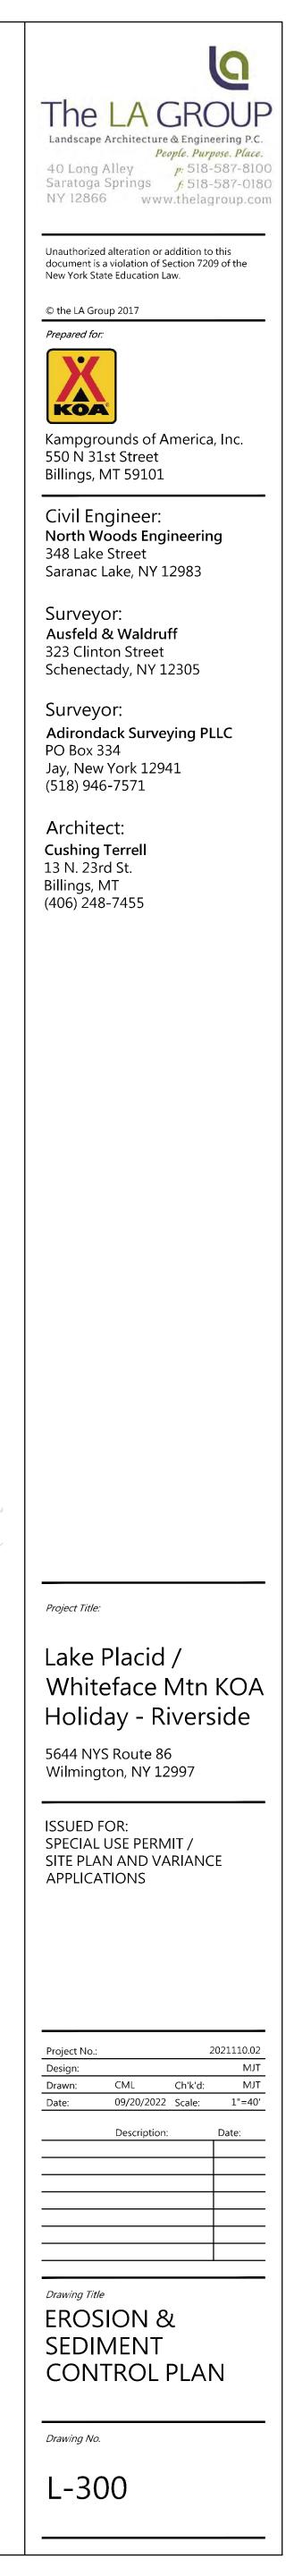


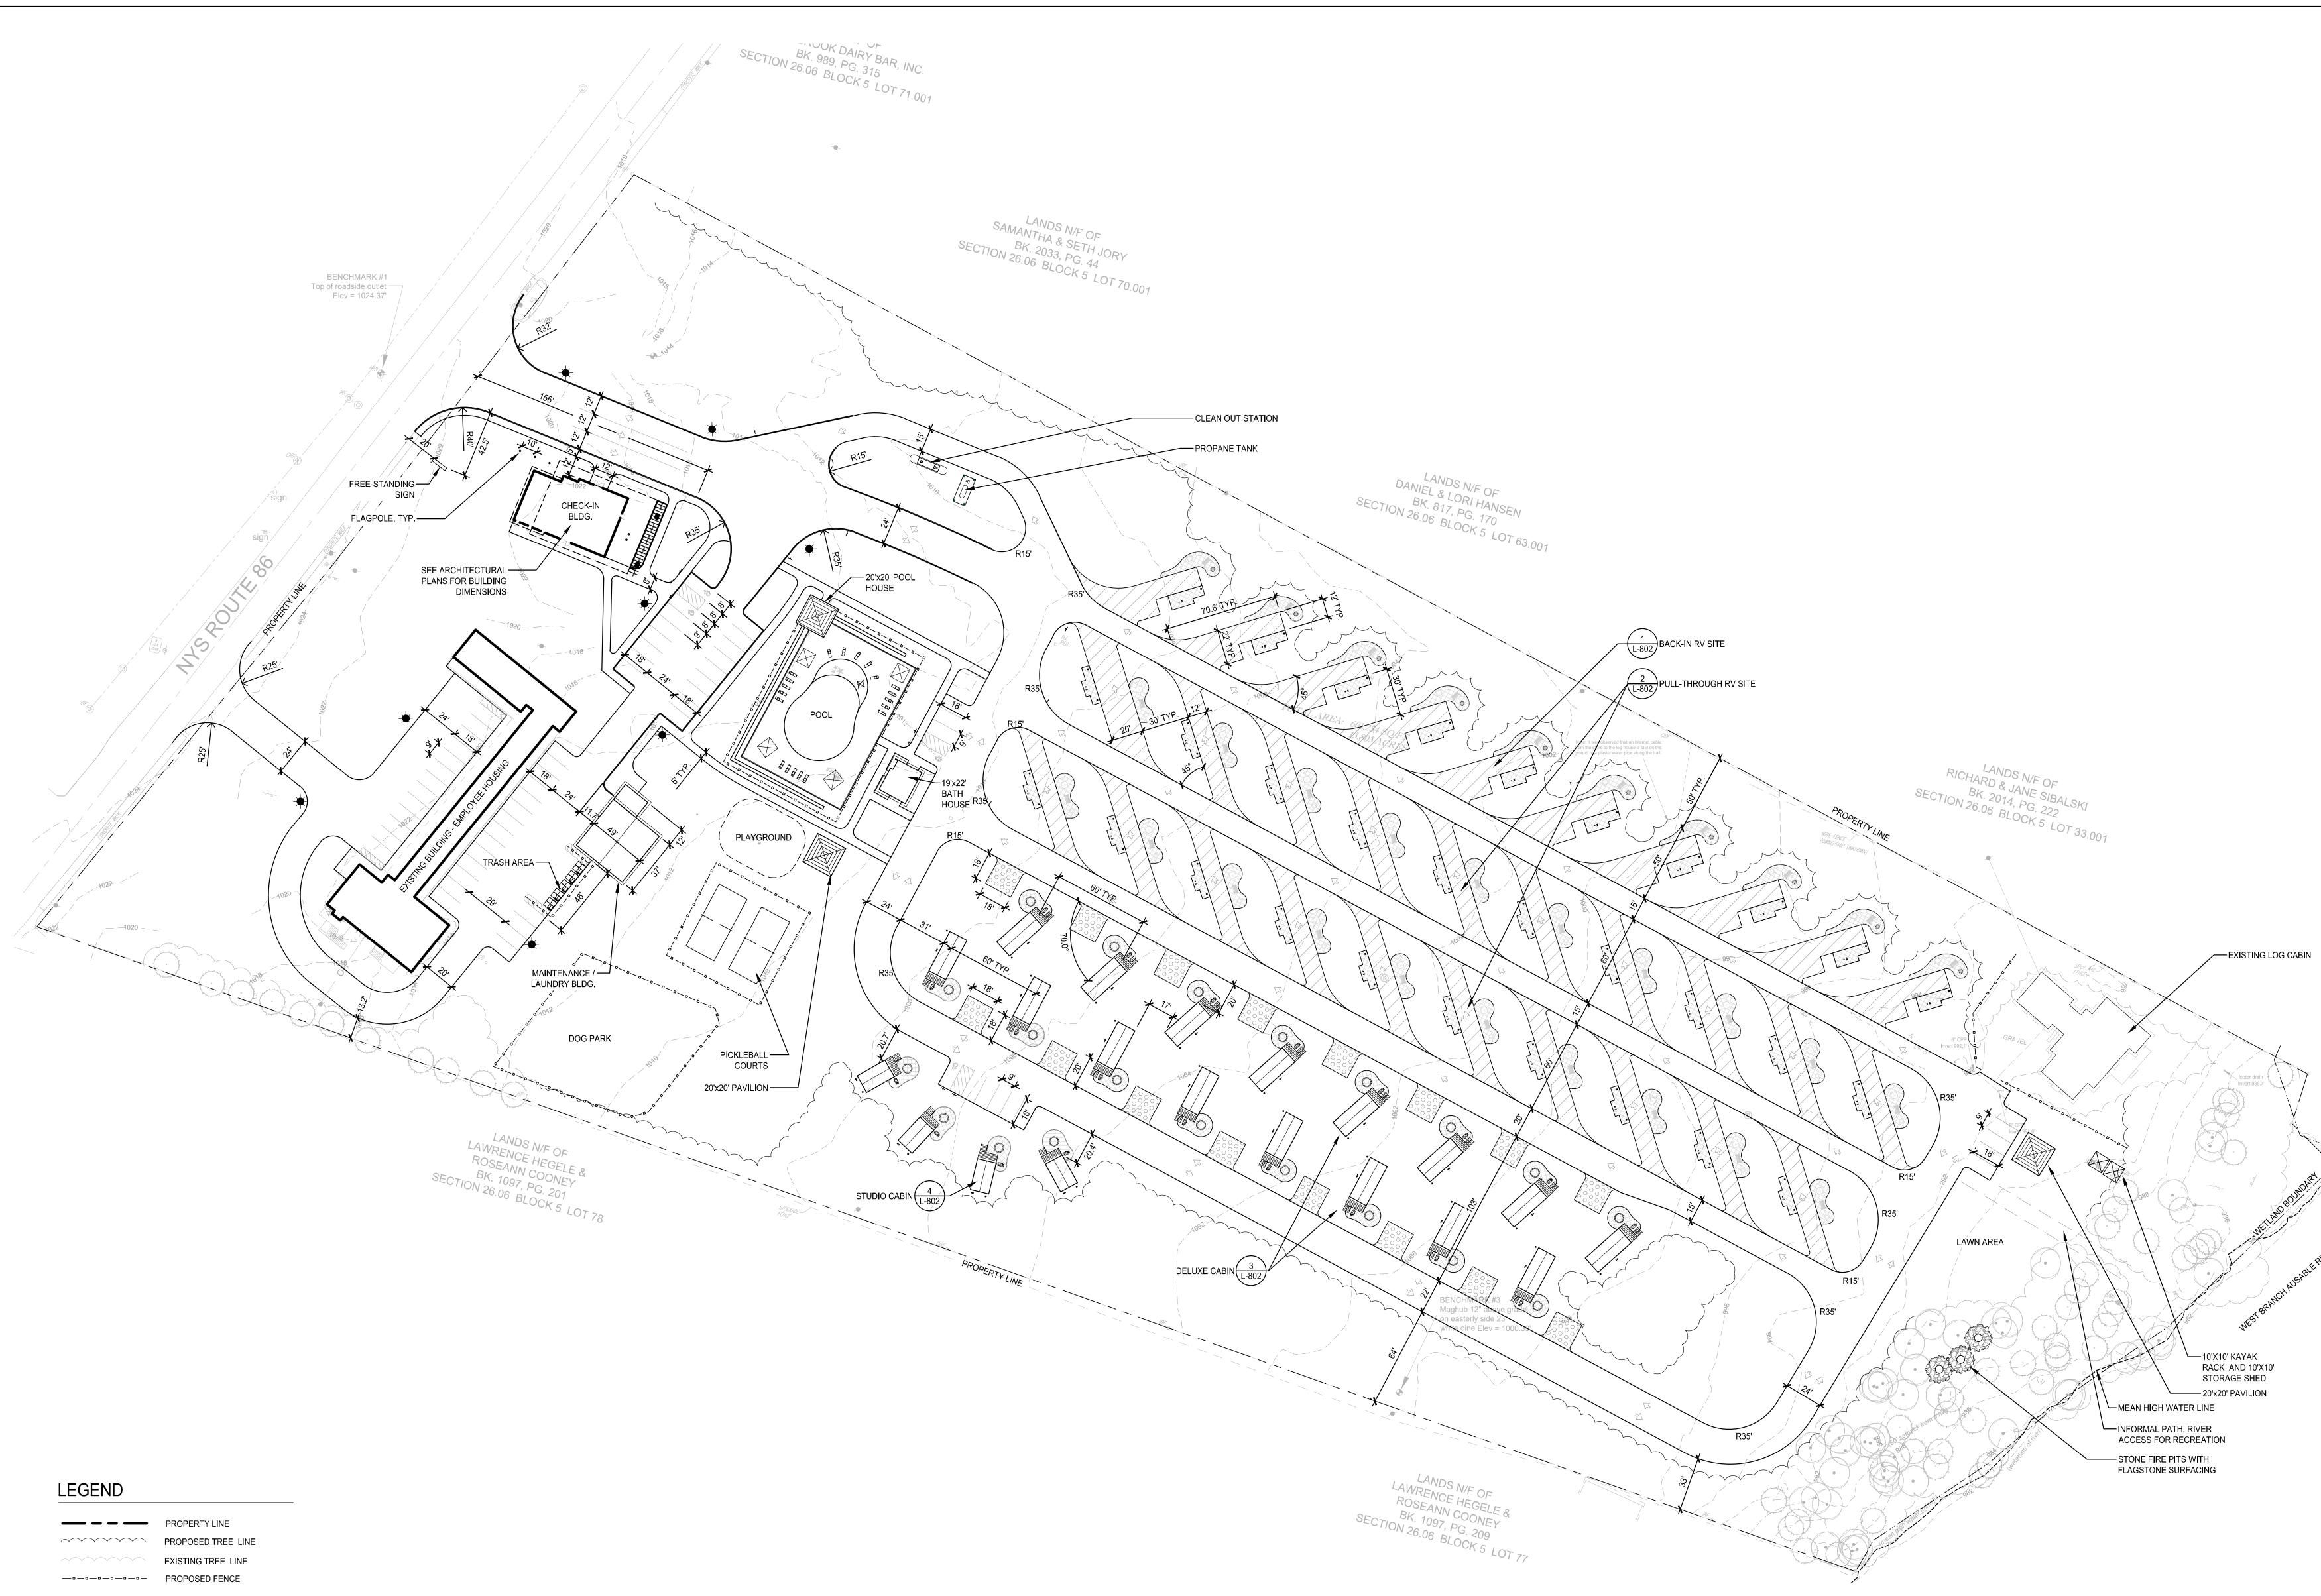

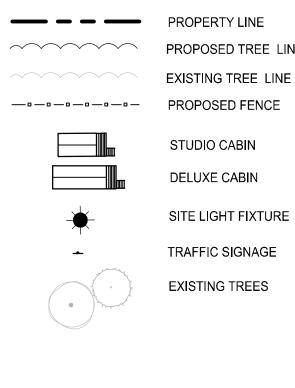


Plotted By: M/ Save Date: 9/1 File Name: G:[\]

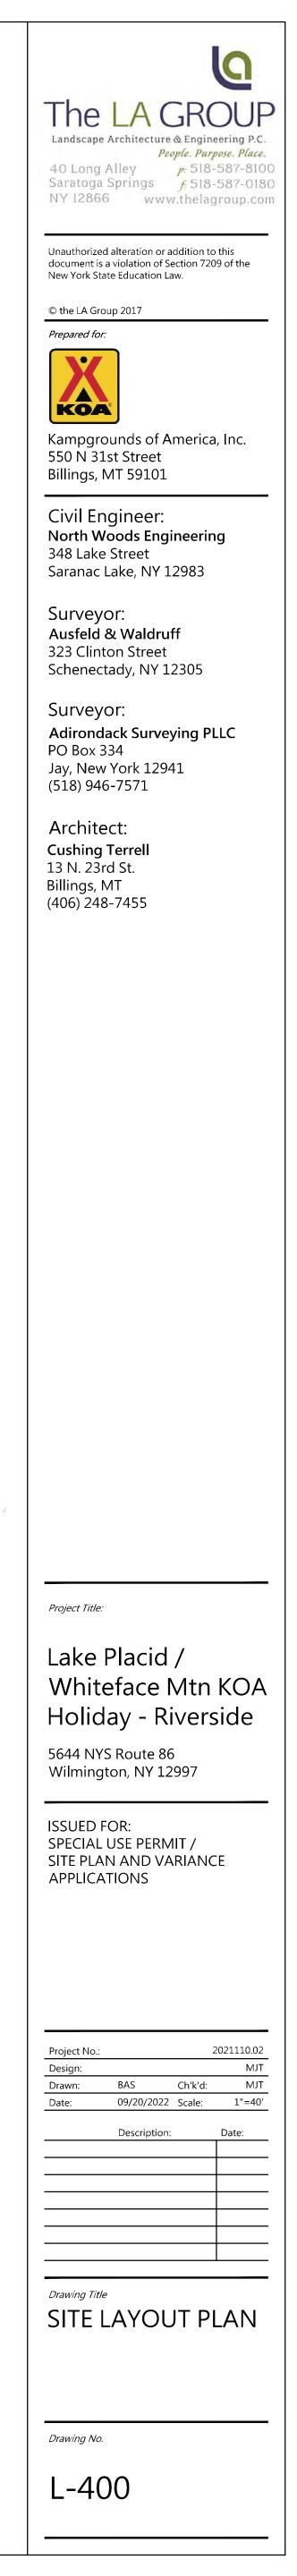


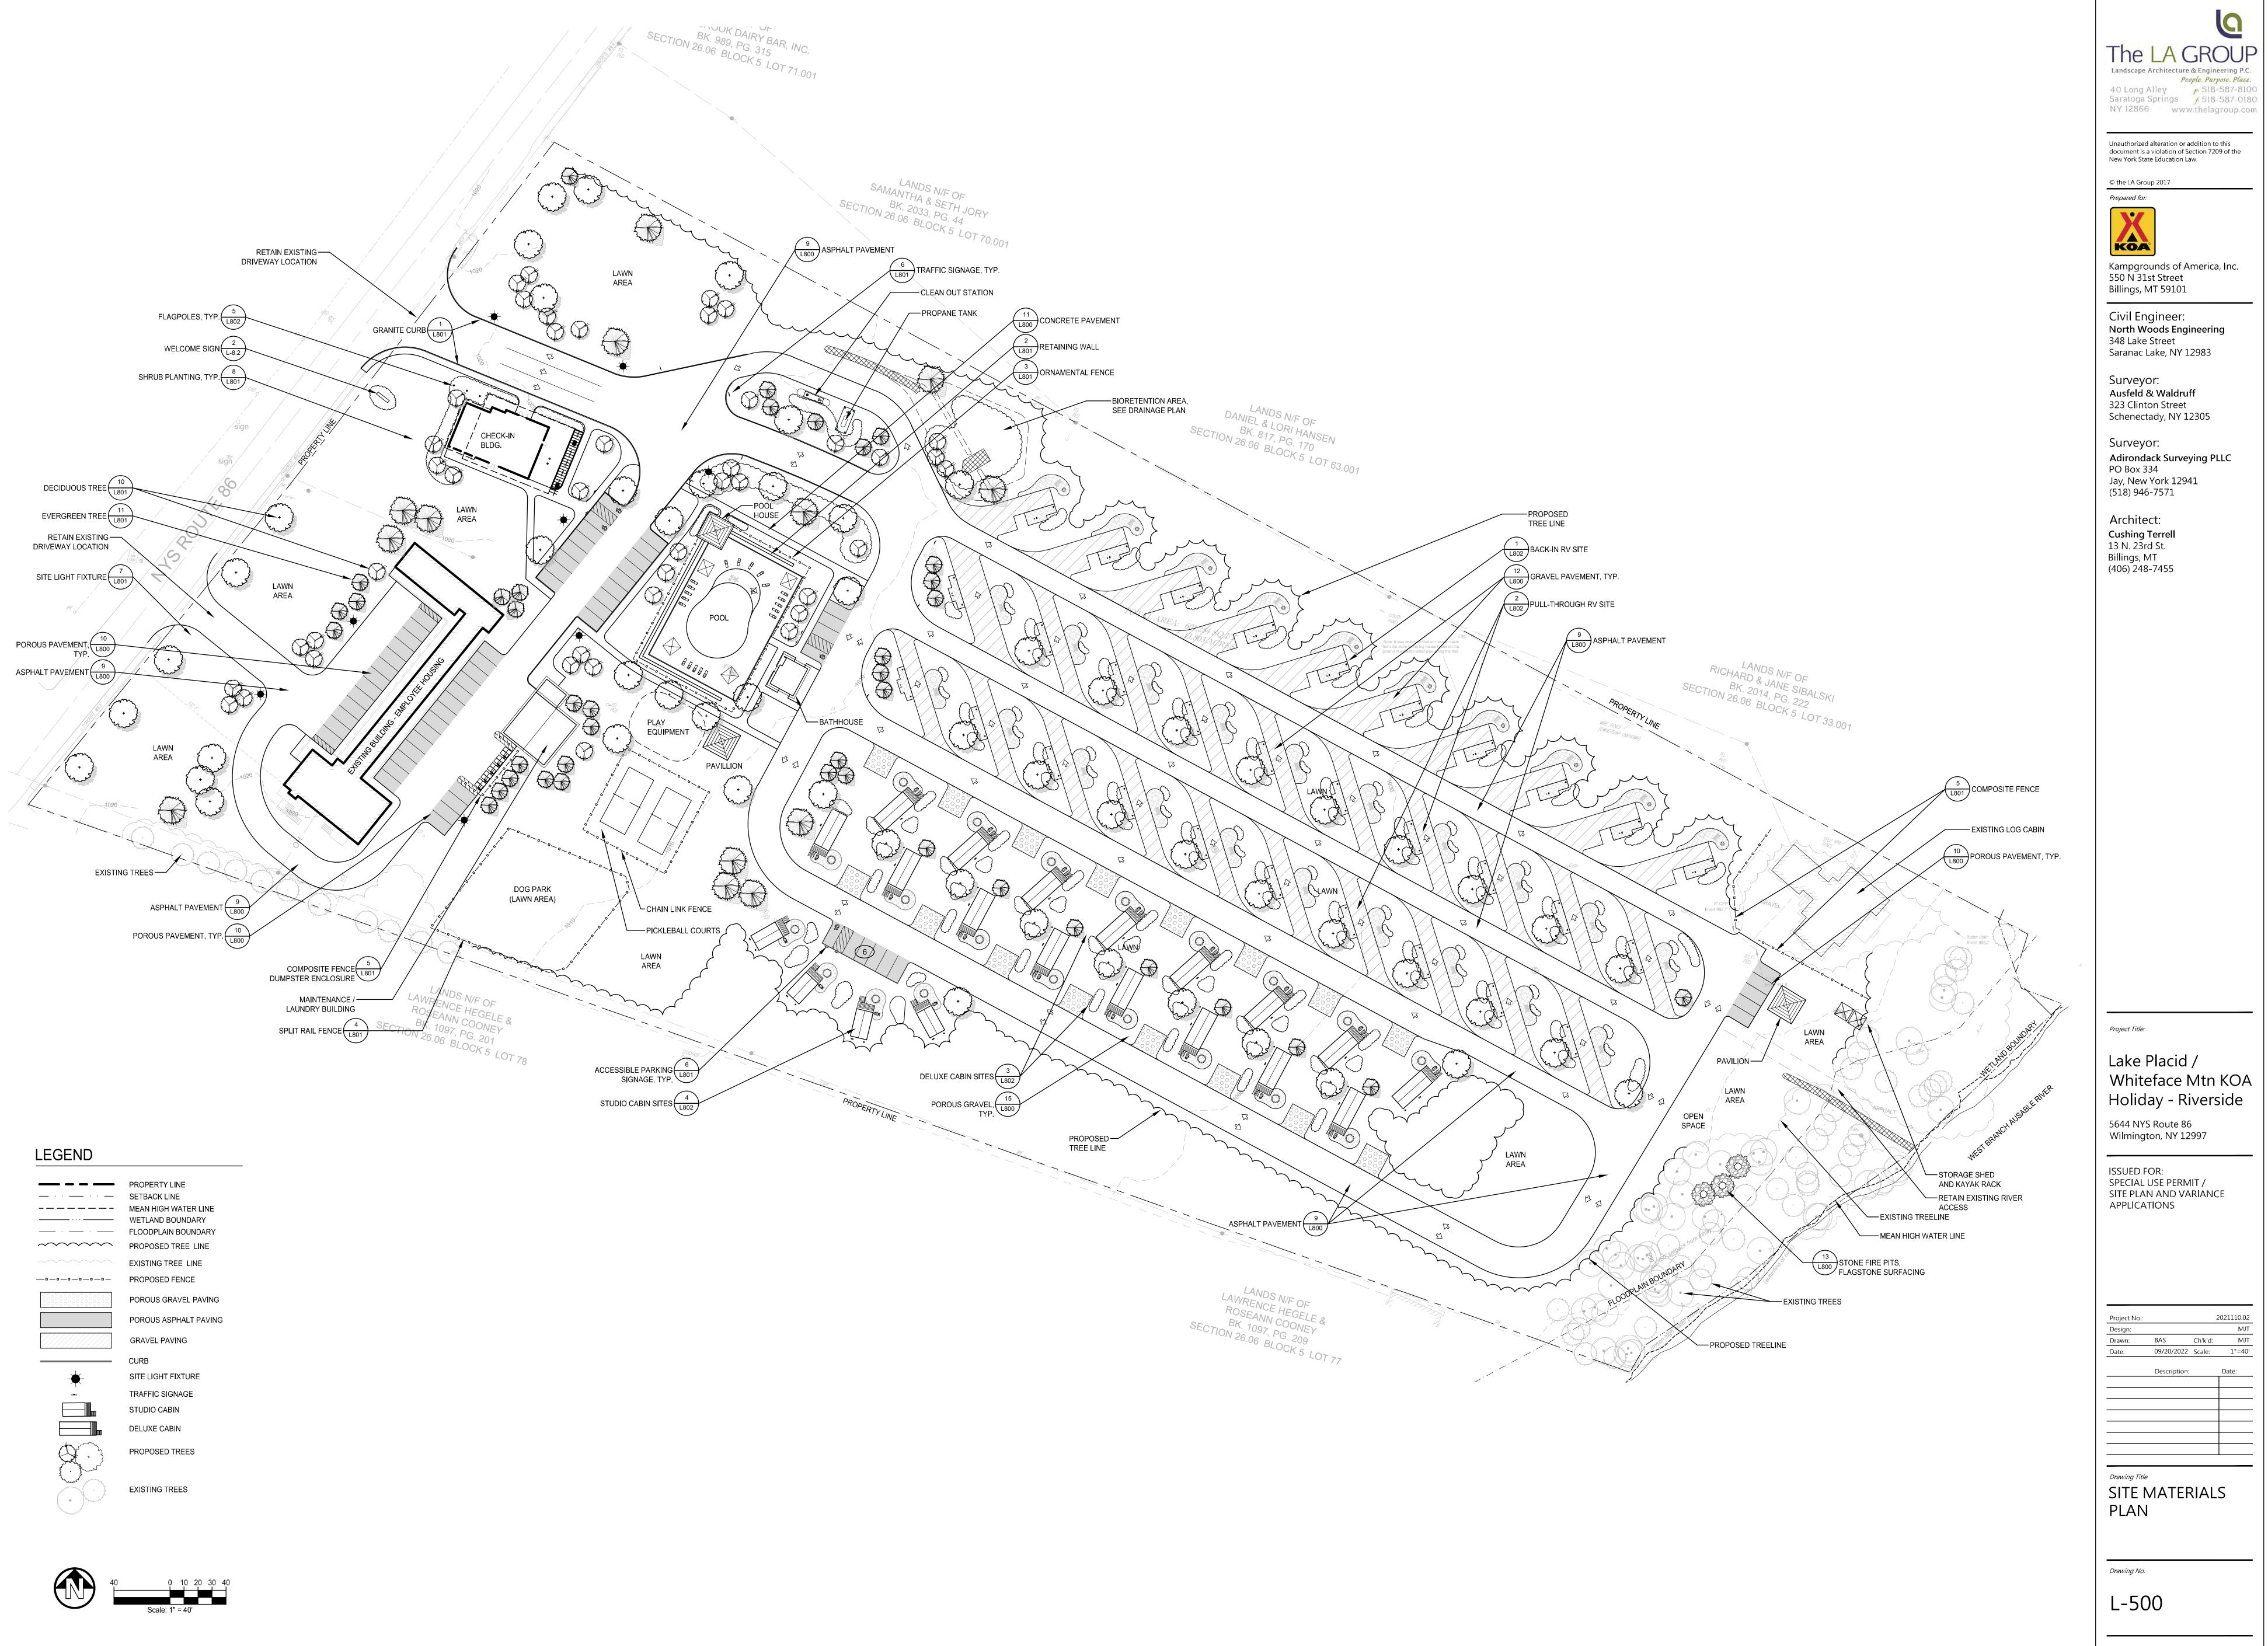



	Ρ
· · · ·	
	S M
·	۷ F
· ·	F
	Ρ
	E
- 0	Ρ
	Ρ
	Ρ
	G
	С
	C S
	Т
	S
	0
	D
	Ρ
South and the second	


Plotted By: M. Save Date: 9// File Name: G:

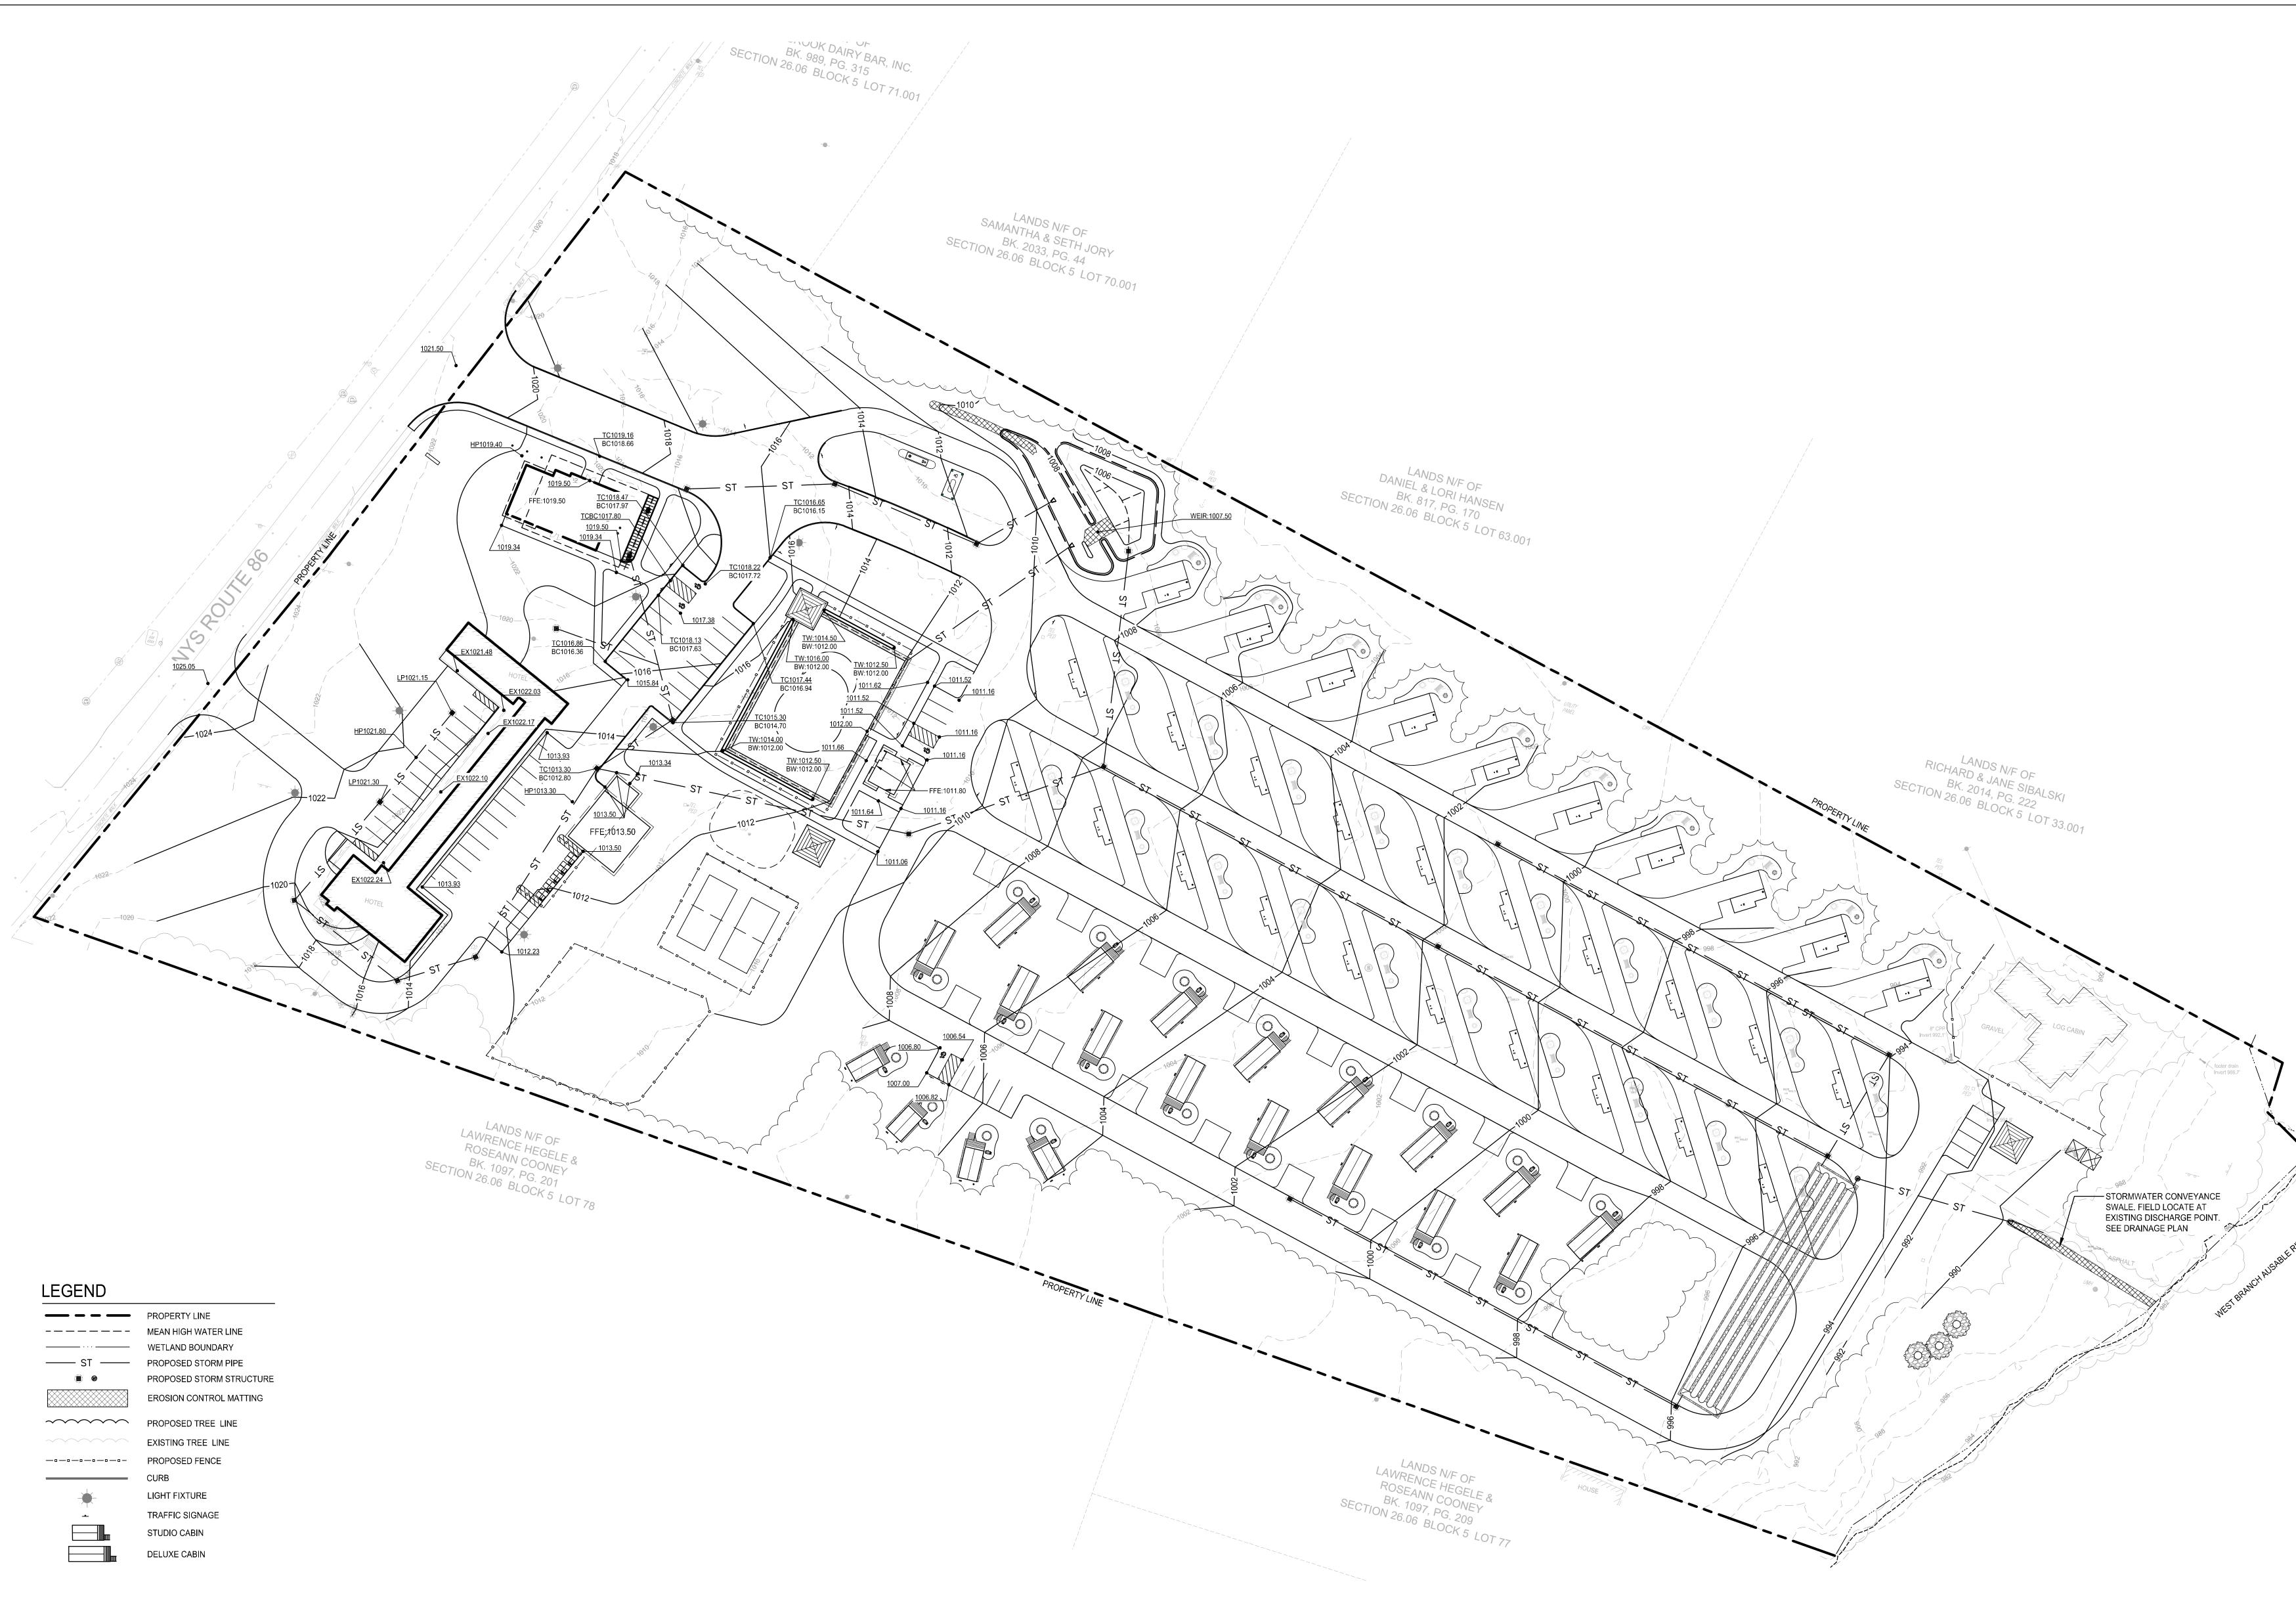


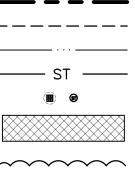


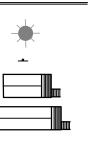

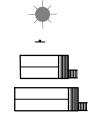

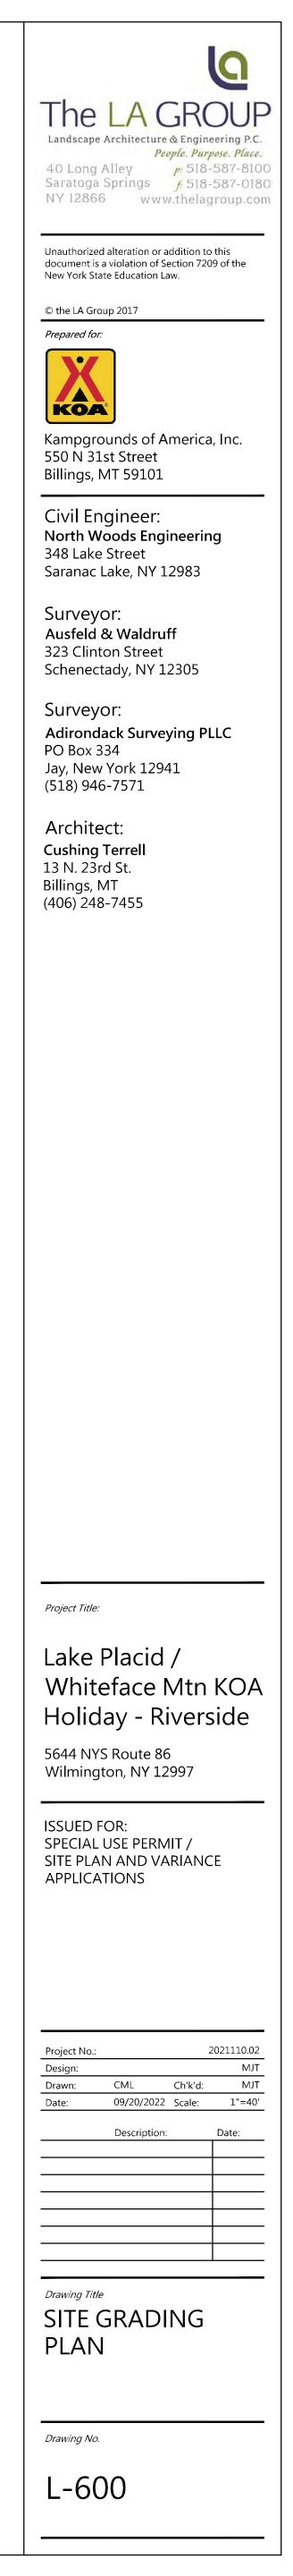


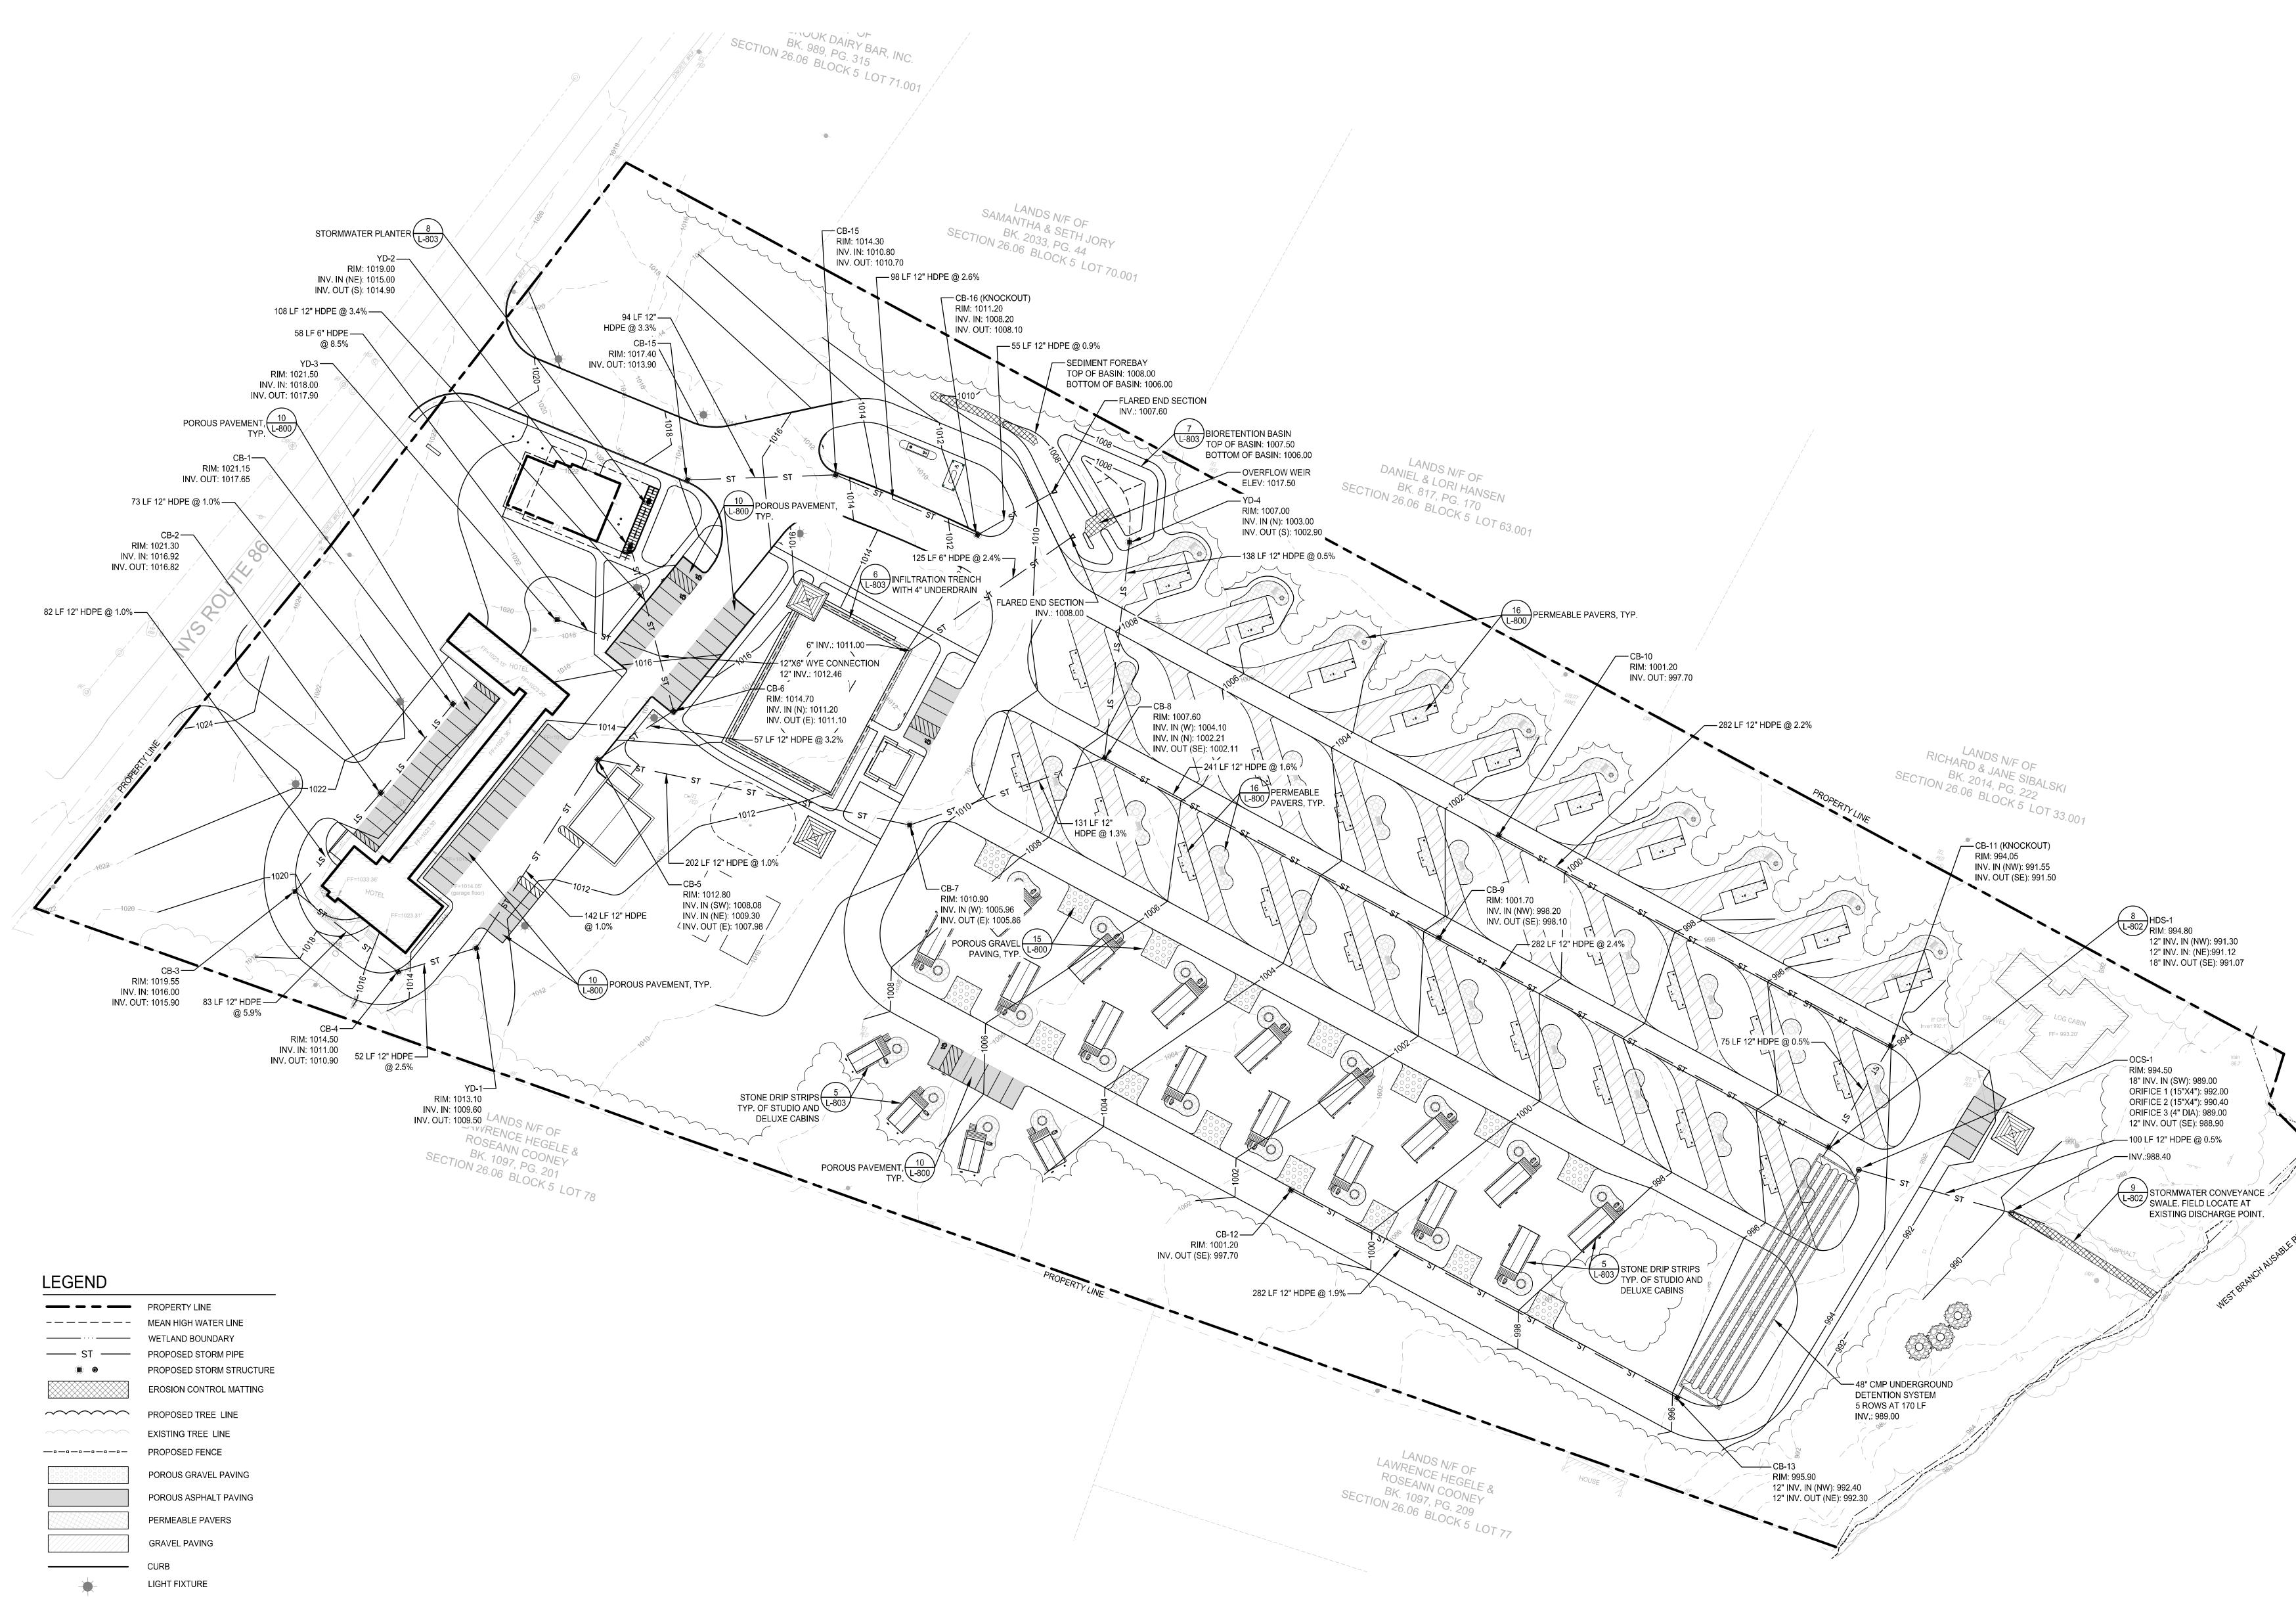


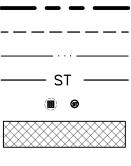


TRAFFIC SIGNAGE STUDIO CABIN DELUXE CABIN



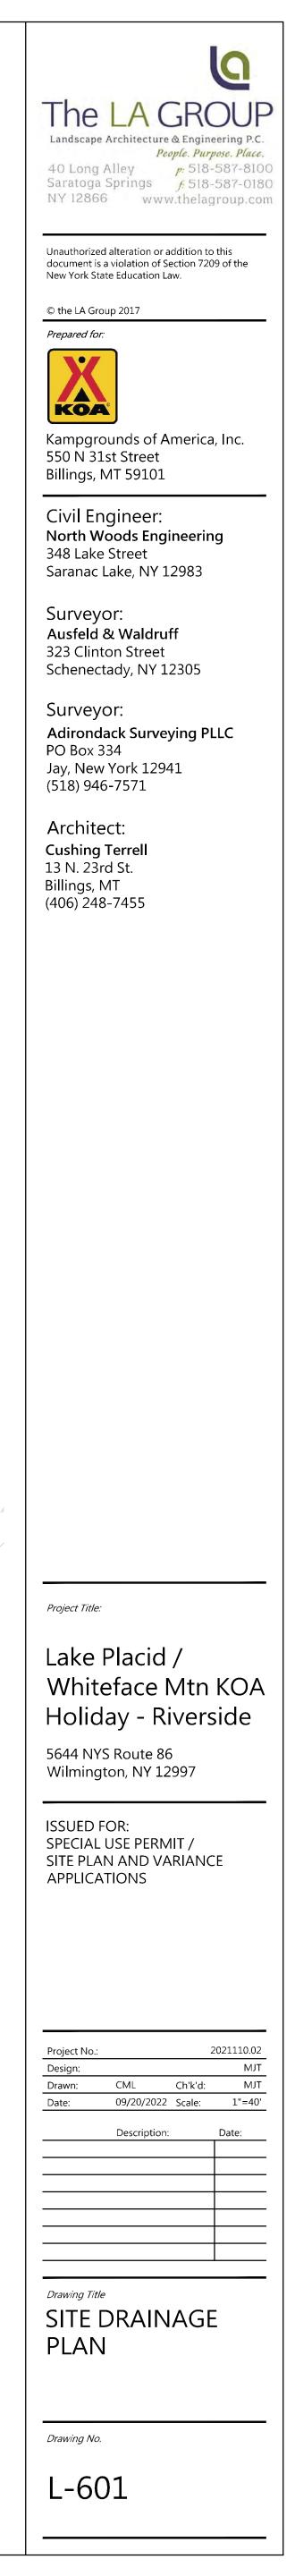


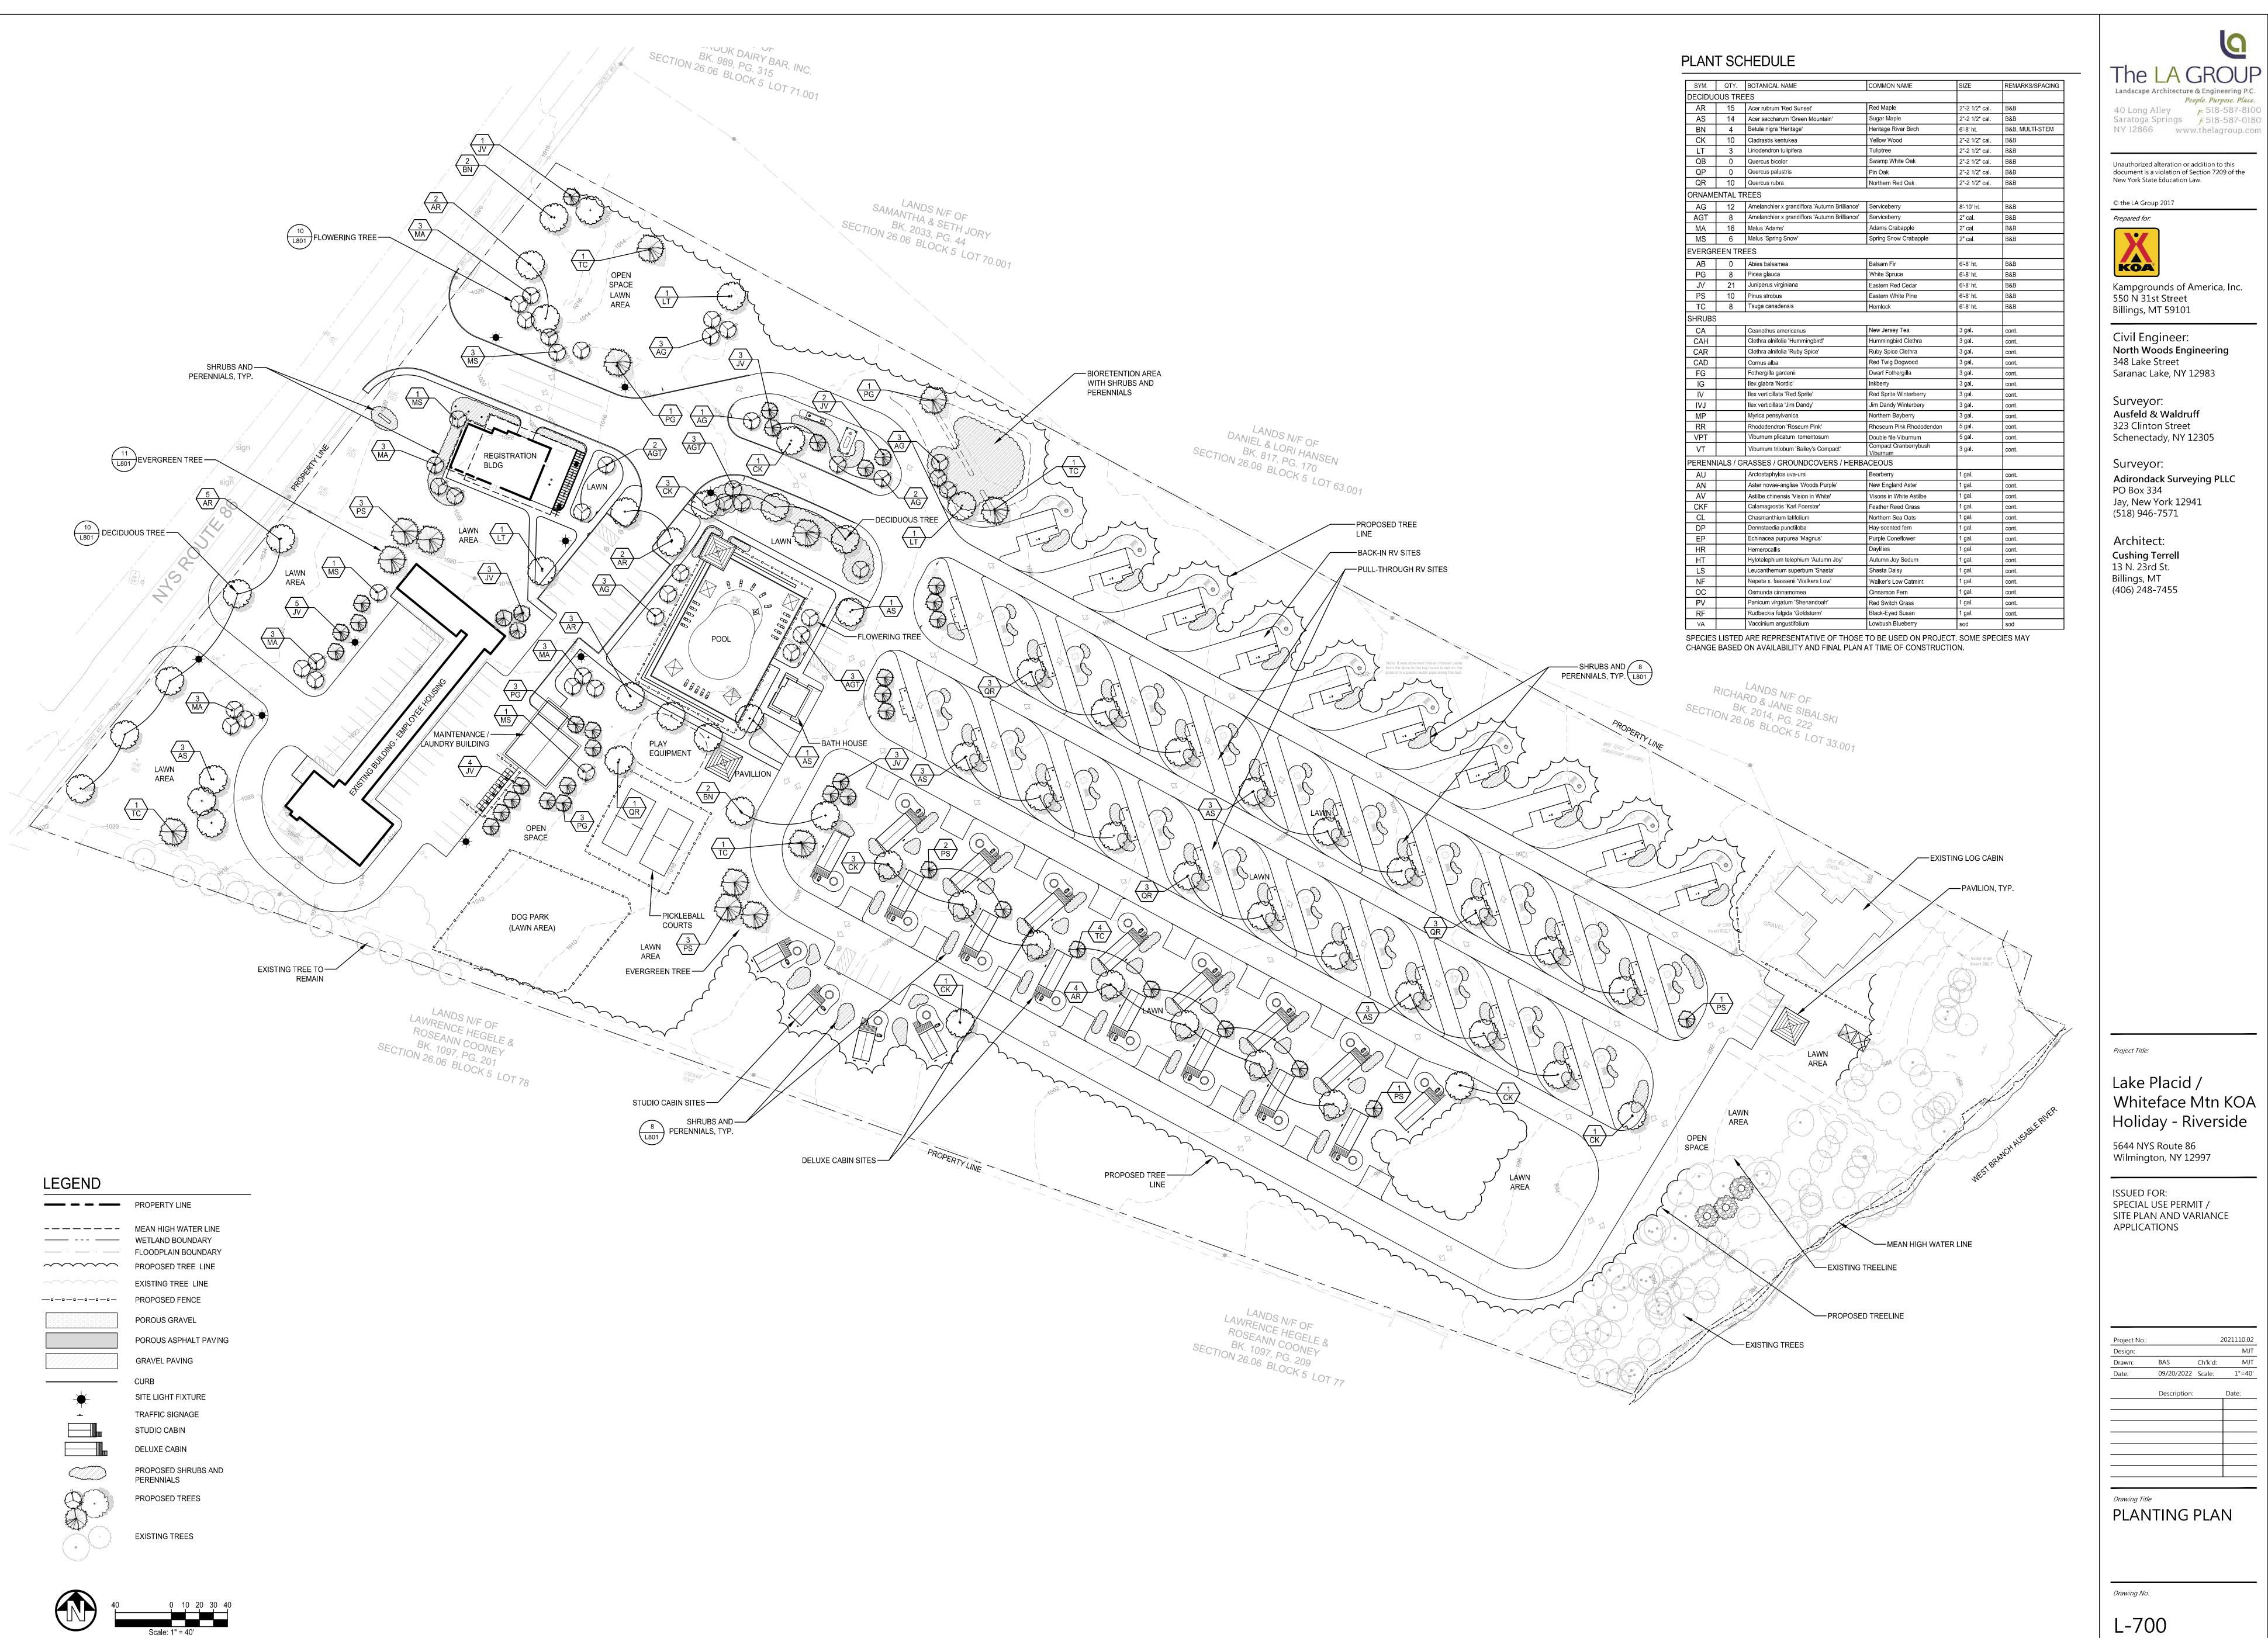


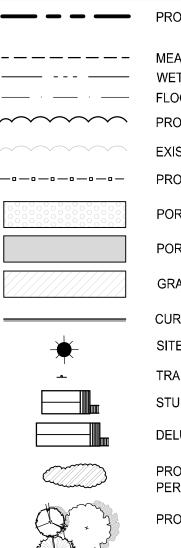


MEAN HIGH WATER LINE
WETLAND BOUNDARY
FLOODPLAIN BOUNDARY
PROPOSED TREE LINE
EXISTING TREE LINE
PROPOSED FENCE
POROUS GRAVEL

SYM.	QTY.	BOTANICAL NAME	COMMON NAME	SIZE	REMARKS/SPA
DECIDU	OUS TRE	ES			
AR	15	Acer rubrum 'Red Sunset'	Red Maple	2"-2 1/2" cal.	B&B
AS	14	Acer saccharum 'Green Mountain'	Sugar Maple	2"-2 1/2" cal.	B&B
BN	4	Betula nigra 'Heritage'	Heritage River Birch	6'-8' ht.	B&B, MULTI-ST
СК	10	Cladrastis kentukea	Yellow Wood	2"-2 1/2" cal.	B&B
LT	3	Liriodendron tulipifera	Tuliptree	2"-2 1/2" cal.	B&B
QB	0	Quercus bicolor	Swamp White Oak	2"-2 1/2" cal.	B&B
QP	0	Quercus palustris	Pin Oak	2"-2 1/2" cal.	B&B
QR	10	Quercus rubra	Northern Red Oak	2"-2 1/2" cal.	B&B
ORNAM	ENTAL TI	REES			
AG	12	Amelanchier x grandiflora 'Autumn Brilliance'	Serviceberry	8'-10' ht.	B&B
AGT	8	Amelanchier x grandiflora 'Autumn Brilliance'	Serviceberry	2" cal.	B&B
MA	16	Malus 'Adams'	Adams Crabapple	2" cal.	B&B
MS	6	Malus 'Spring Snow'	Spring Snow Crabapple	2" cal.	B&B
EVERGE	REEN TRI	EES			
AB	0	Abies balsamea	Balsam Fir	6'-8' ht.	B&B
PG	8	Picea glauca	White Spruce	6'-8' ht.	B&B
JV	21	Juniperus virginiana	Eastern Red Cedar	6'-8' ht.	B&B
PS	10	Pinus strobus	Eastern White Pine	6'-8' ht.	B&B
тс	8	Tsuga canadensis	Hemlock	6'-8' ht.	B&B
SHRUBS					
CA	-	Ceanothus americanus	New Jersey Tea	3 gal.	cont.
CAH		Clethra alnifolia 'Hummingbird'	Hummingbird Clethra	3 gal.	cont.
CAR		Clethra alnifolia 'Ruby Spice'	Ruby Spice Clethra	3 gal.	cont.
CAD		Cornus alba	Red Twig Dogwood	3 gal.	cont.
FG		Fothergilla gardenii	Dwarf Fothergilla	3 gal.	cont.
IG		Ilex glabra 'Nordic'	Inkberry	3 gal.	cont.
IV		Ilex verticillata 'Red Sprite'	Red Sprite Winterberry	3 gal.	cont.
IVJ		Ilex verticillata 'Jim Dandy'	Jim Dandy Winterbery	3 gal.	cont.
MP		Myrica pensylvanica	Northern Bayberry	3 gal.	cont.
RR		Rhododendron 'Roseum Pink'	Rhoseum Pink Rhododendon	5 gal.	cont.
VPT		Viburnum plicatum tomentosum	Double file Viburnum	5 gal.	cont.
VT		Viburnum trilobum 'Bailey's Compact'	Compact Cranberrybush	3 gal.	cont.
		RASSES / GROUNDCOVERS / HERB			
	T		1	4	
AU		Arctostaphylos uva-ursi Aster novae-angliae 'Woods Purple'	Bearberry	1 gal.	cont.
AN		· · · · ·	New England Aster	1 gal.	cont.
AV		Astilbe chinensis 'Vision in White' Calamagrostis 'Karl Foerster'	Visons in White Astilbe	1 gal.	cont.
CKF			Feather Reed Grass	1 gal. 1 gal.	cont.
CL DP		Chasmanthium latifolium Dennstaedia punctiloba	Northern Sea Oats Hay-scented fern	1 gal.	cont.
EP		Echinacea purpurea 'Magnus'	Purple Coneflower	1 gal.	cont.
		Hemerocallis	Daylilies	1 gal.	cont.
		Hylotelephium telephium 'Autumn Joy'	Autumn Joy Sedum	1 gal.	cont.
LS		Leucanthemum superbum 'Shasta'	Shasta Daisy	1 gal.	cont.
NF		Nepeta x. faassenii 'Walkers Low'	Walker's Low Catmint	1 gal.	
	<u> </u>	Osmunda cinnamomea	Cinnamon Fern	1 gal.	cont.
PV		Panicum virgatum 'Shenandoah'	Red Switch Grass	1 gal.	cont.
RF		Rudbeckia fulgida 'Goldsturm'	Black-Eyed Susan	1 gal.	cont.
VA	<u> </u>	Vaccinium angustifolium	Lowbush Blueberry	sod	sod
				sou	500

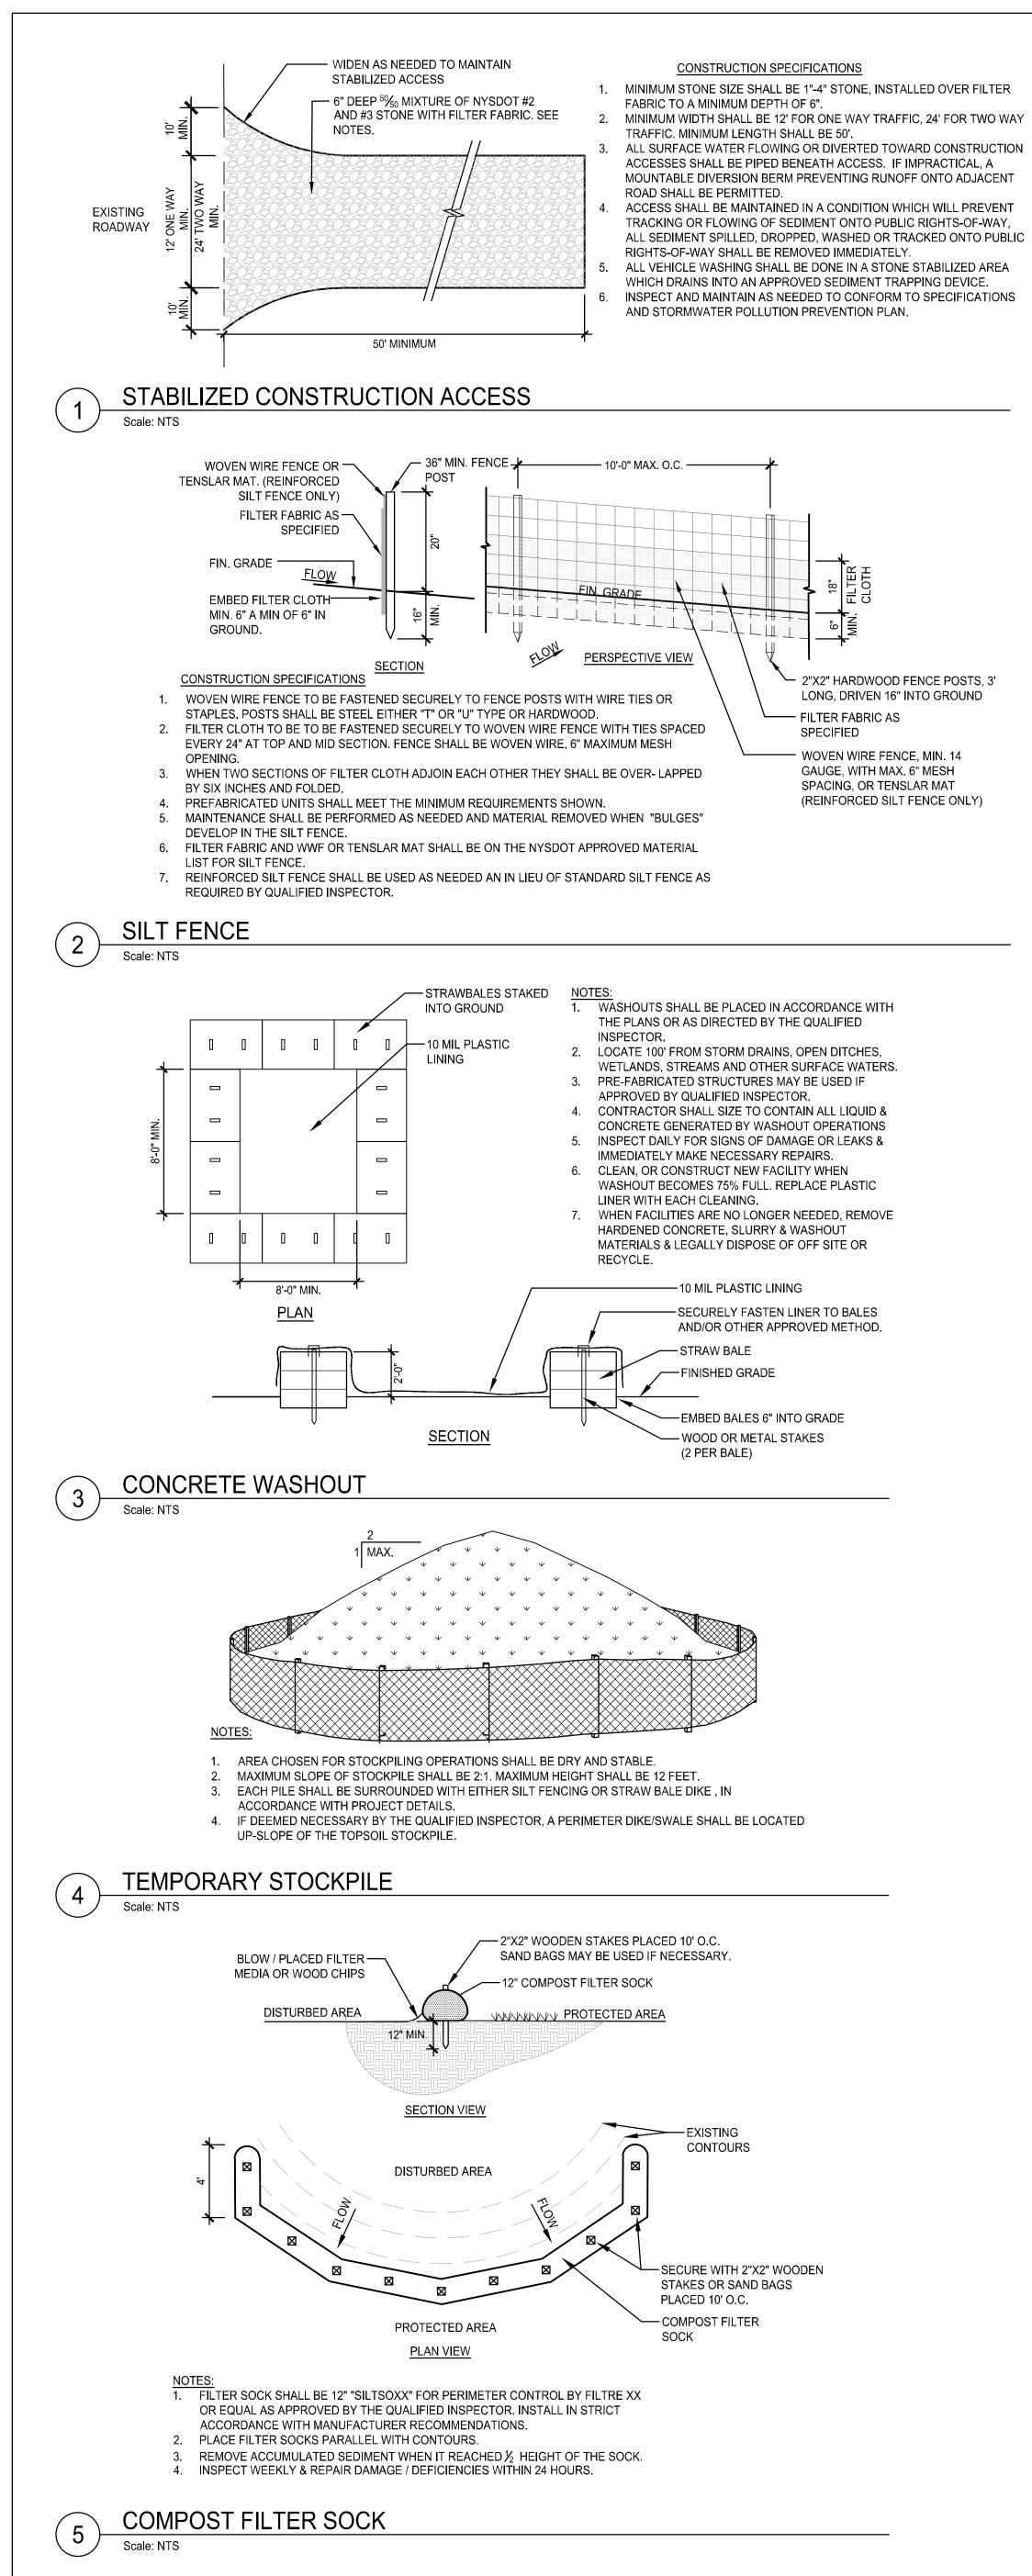

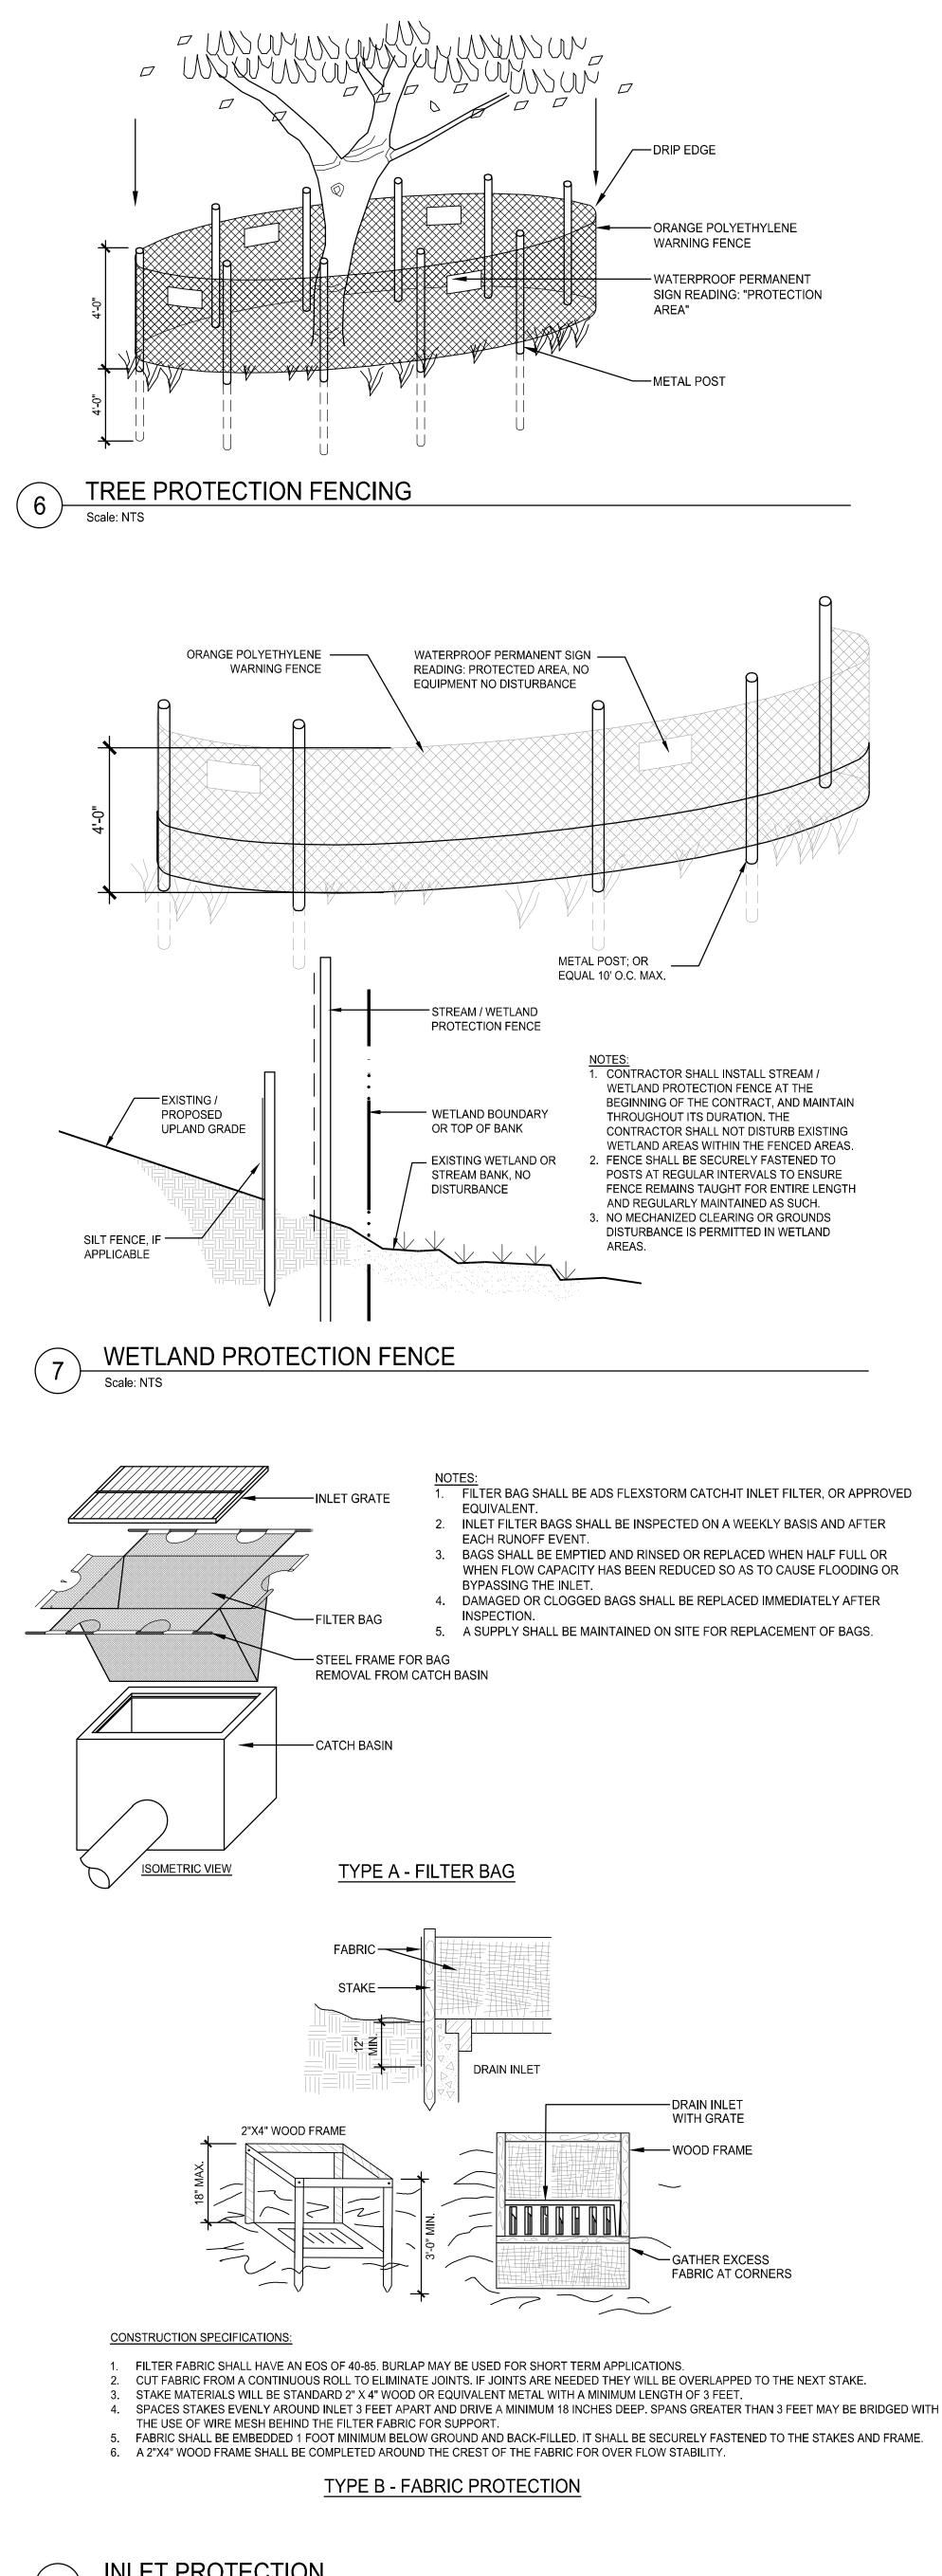


INLET PROTECTION

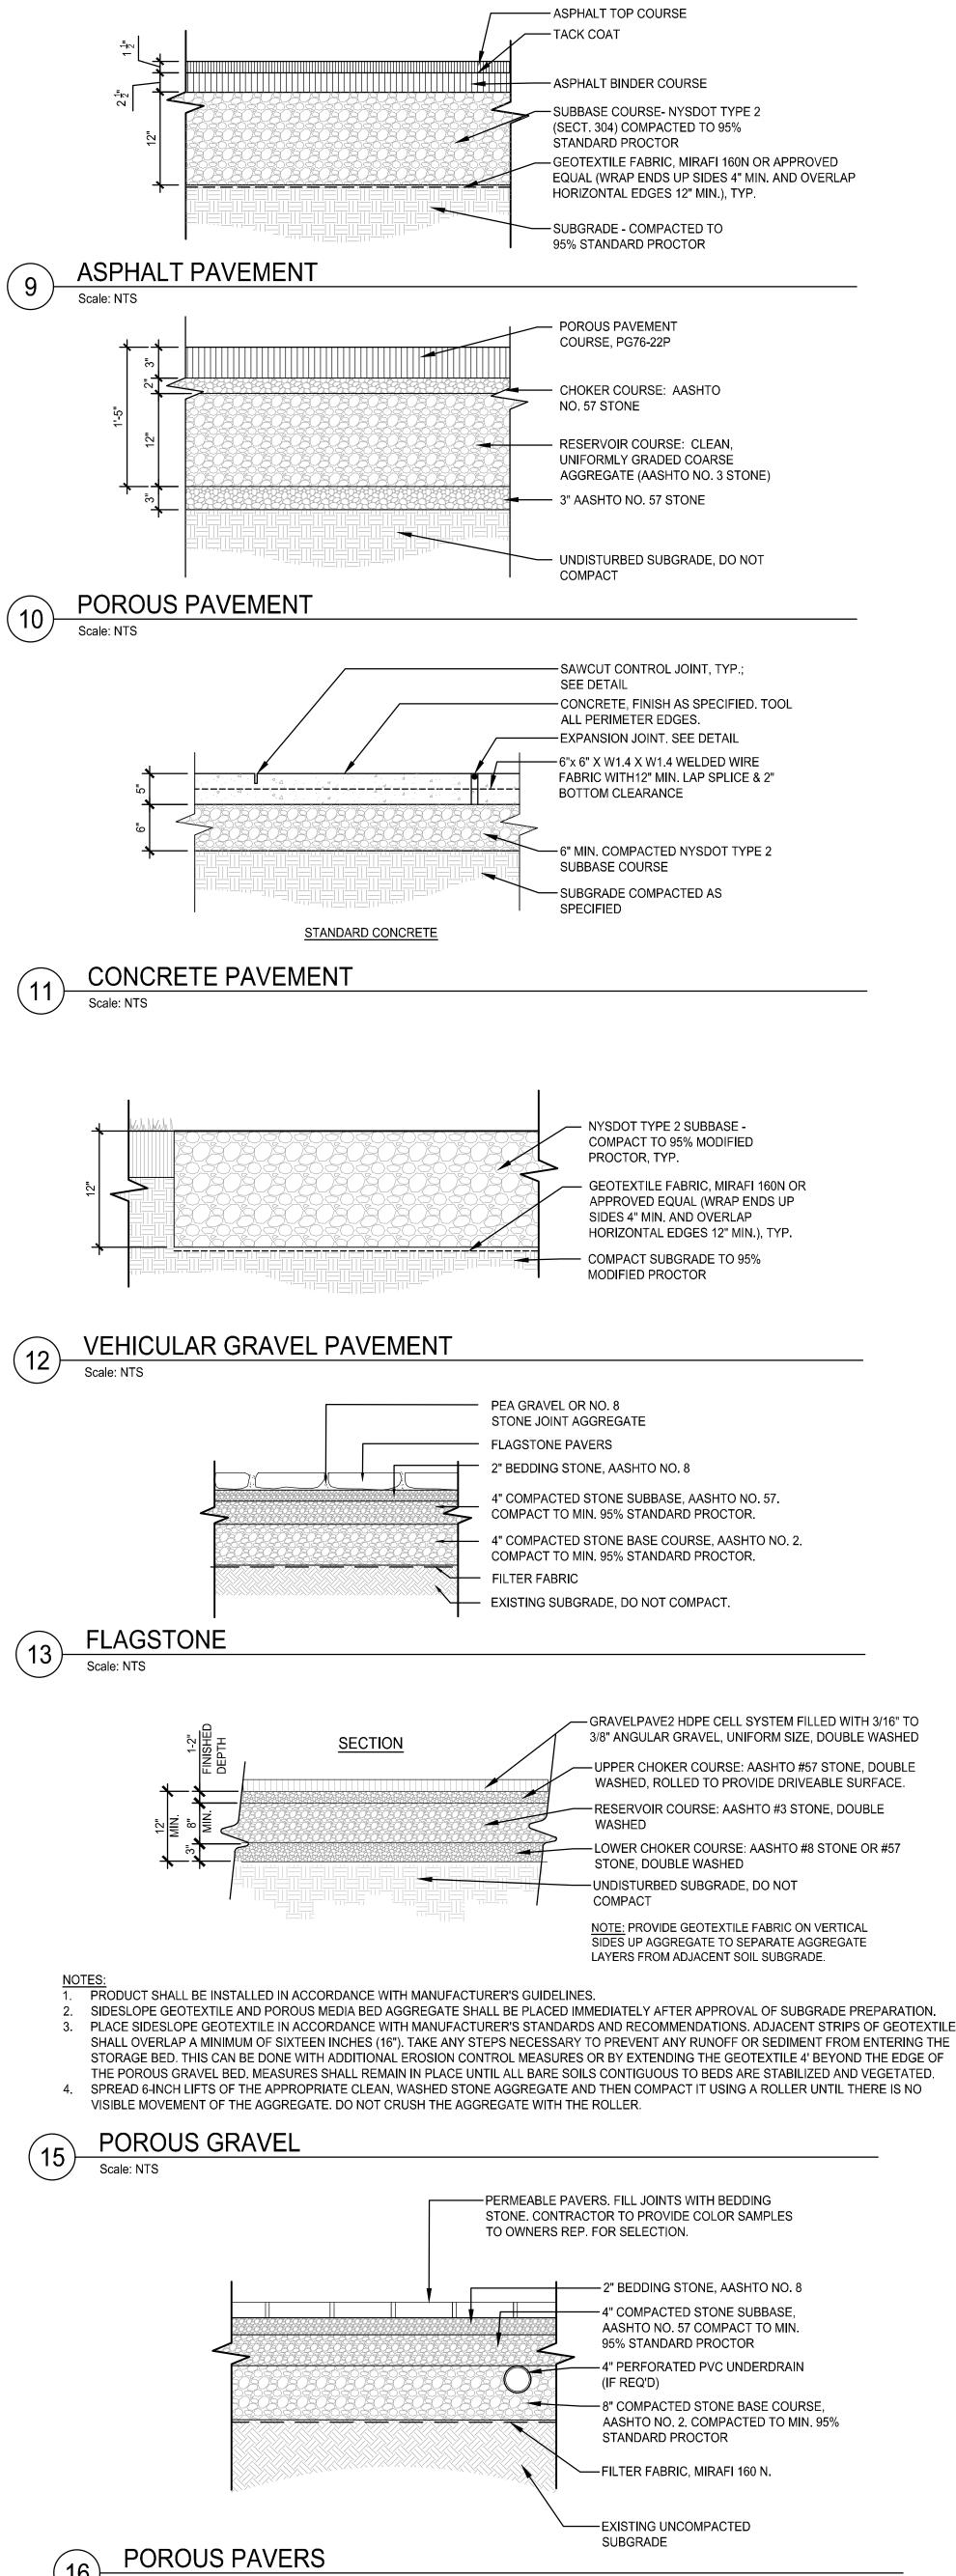


Scale: NTS


ne Landscape Architecture & Engineering P.C. People, Purpose, Place. 40 Long Alley p: 518-587-8100 Saratoga Springs ______518-587-0180 NY 12866 www.thelagroup.com Unauthorized alteration or addition to this document is a violation of Section 7209 of the New York State Education Law. © the LA Group 2017 Prepared for: 1.1 KOA Kampgrounds of America, Inc. 550 N 31st Street Billings, MT 59101 Civil Engineer: North Woods Engineering 348 Lake Street Saranac Lake, NY 12983 Surveyor: Ausfeld & Waldruff 323 Clinton Street Schenectady, NY 12305 Surveyor: Adirondack Surveying PLLC PO Box 334 Jay, New York 12941 (518) 946-7571 Architect: Cushing Terrell 13 N. 23rd St. Billings, MT (406) 248-7455 Project Title: Lake Placid / Whiteface Mtn KOA Holiday - Riverside 5644 NYS Route 86 Wilmington, NY 12997 **ISSUED FOR:** SPECIAL USE PERMIT / SITE PLAN AND VARIANCE APPLICATIONS 2021110.02 Project No.: MIT BAS Ch'k'd: MJT Drawn: 09/20/2022 Scale: Date: Description: Date Drawing Title SITE DETAILS Drawing No. L-800

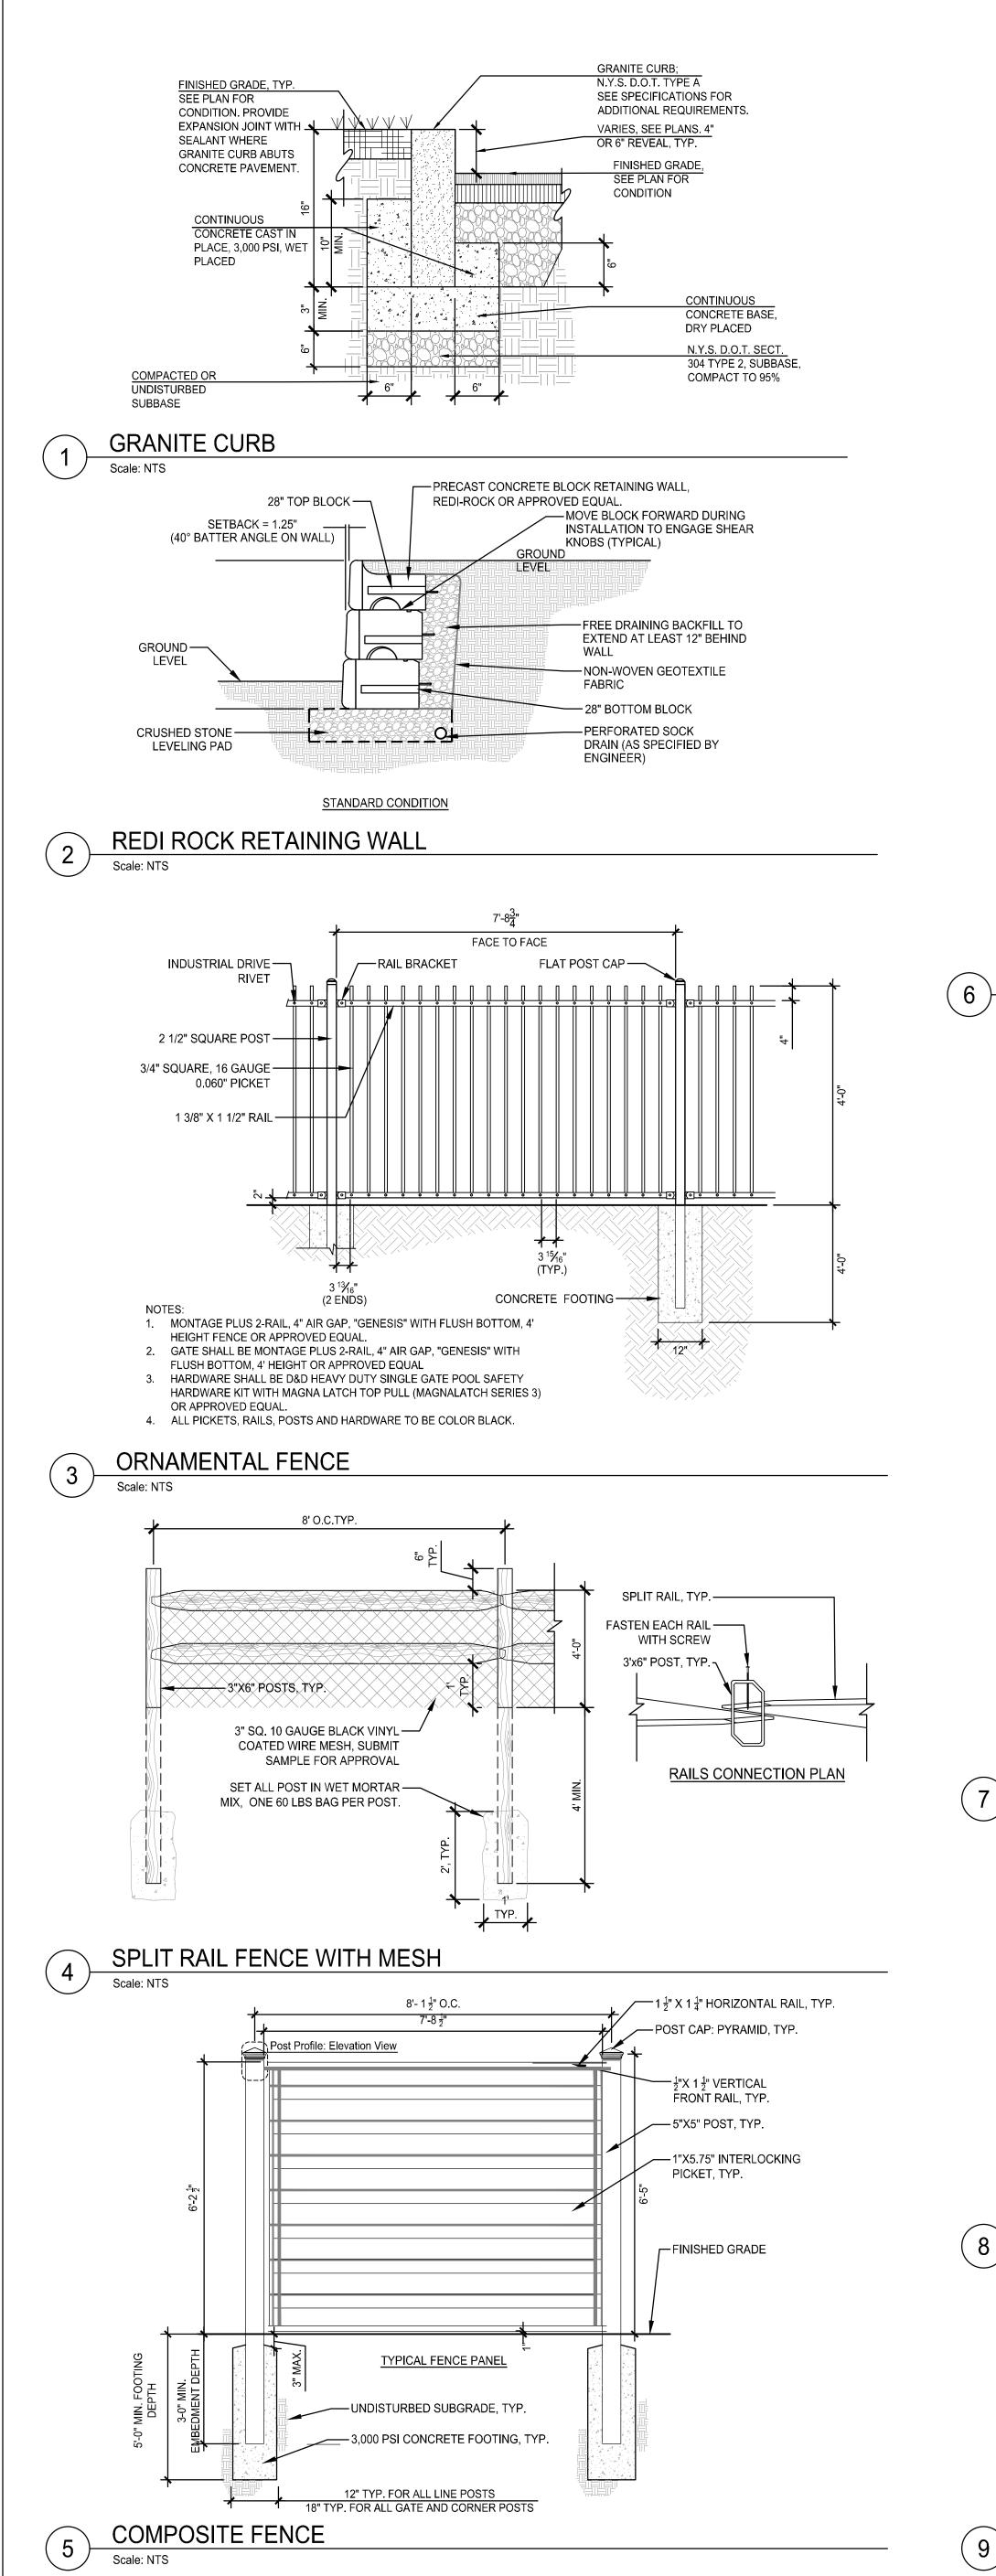


9

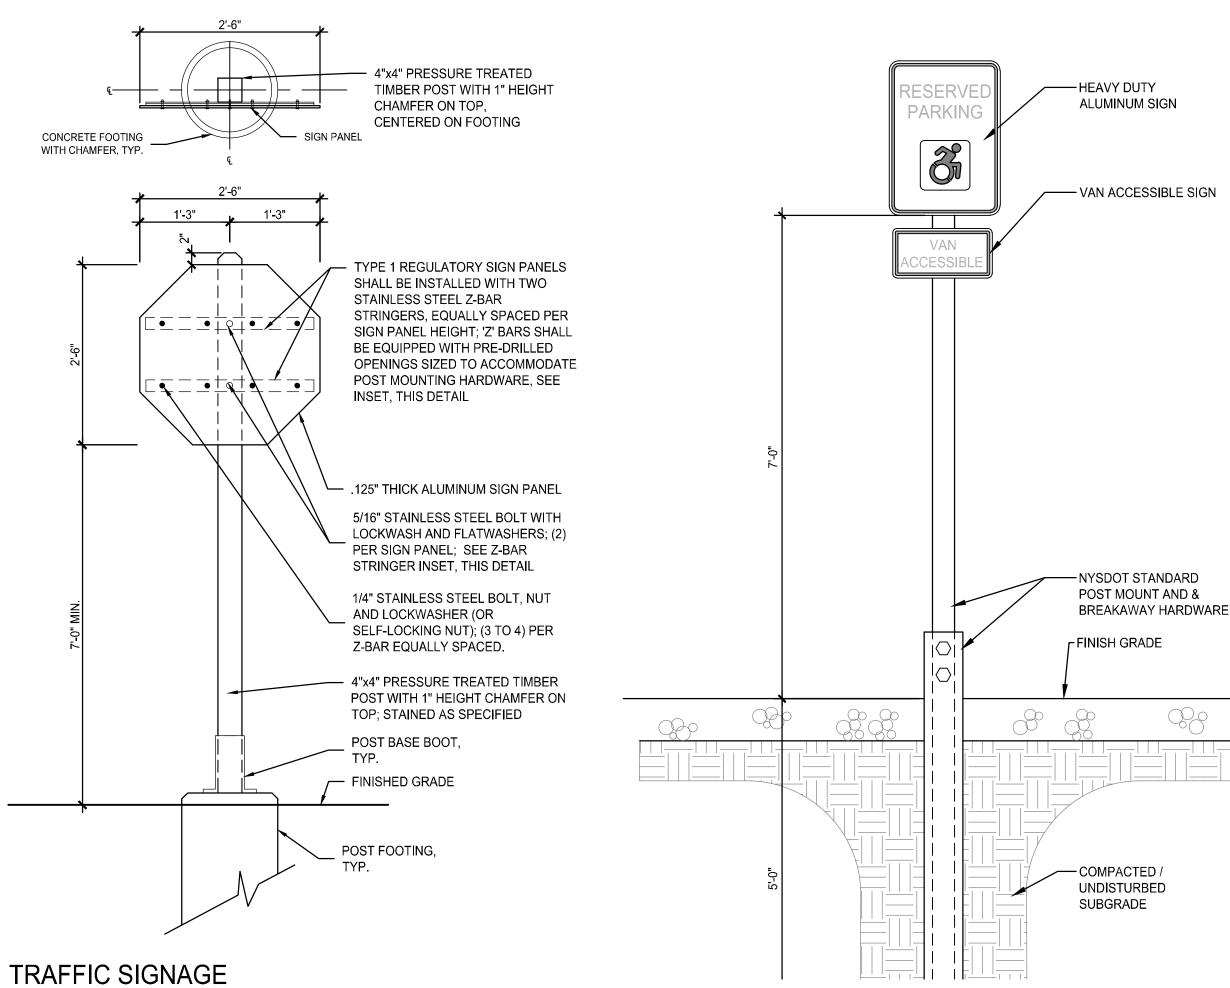




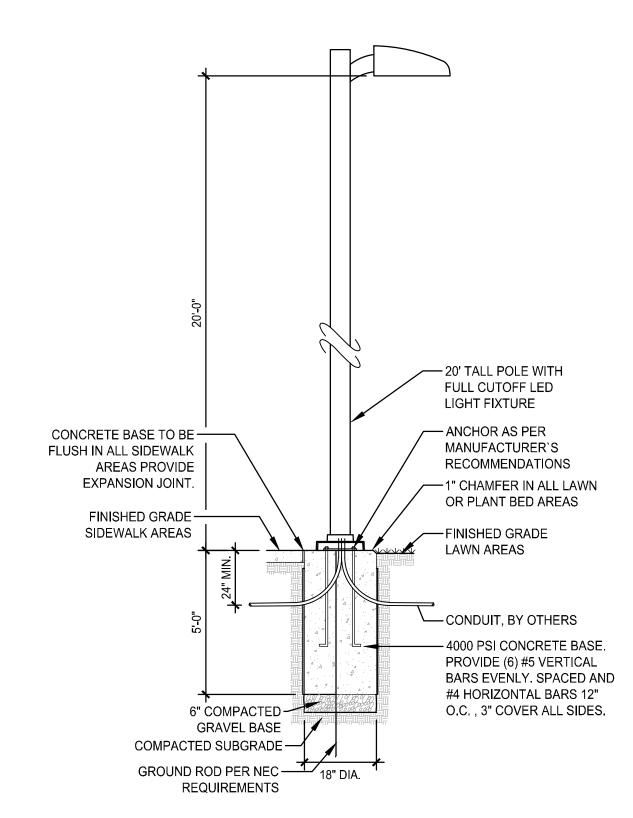




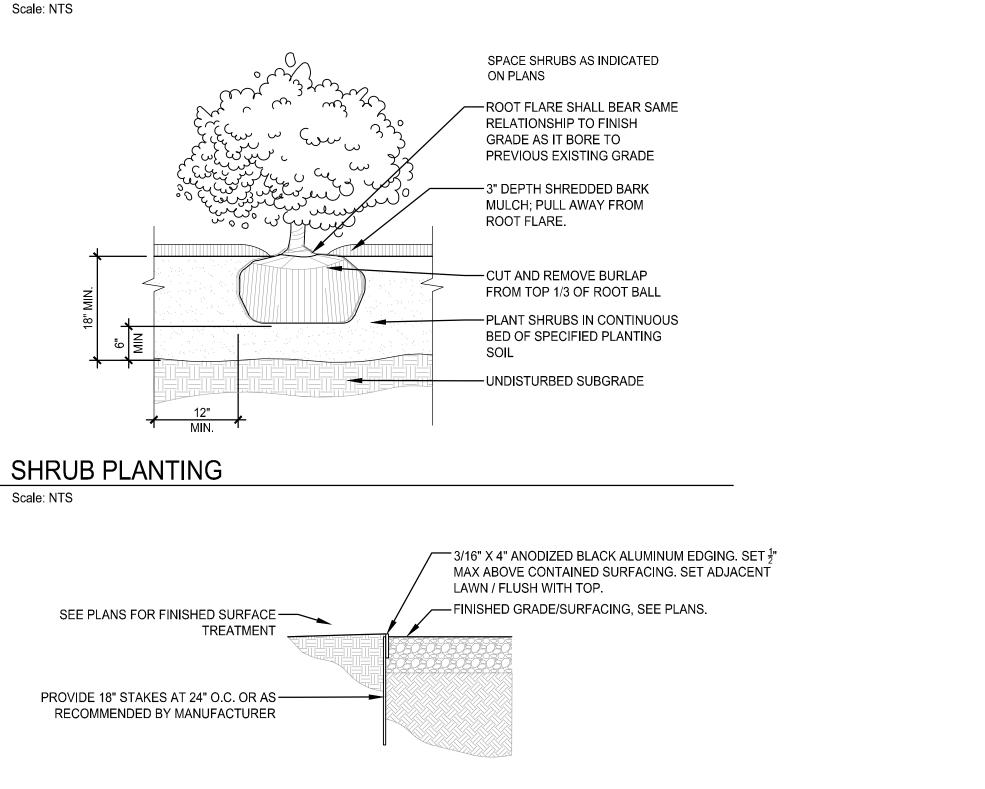

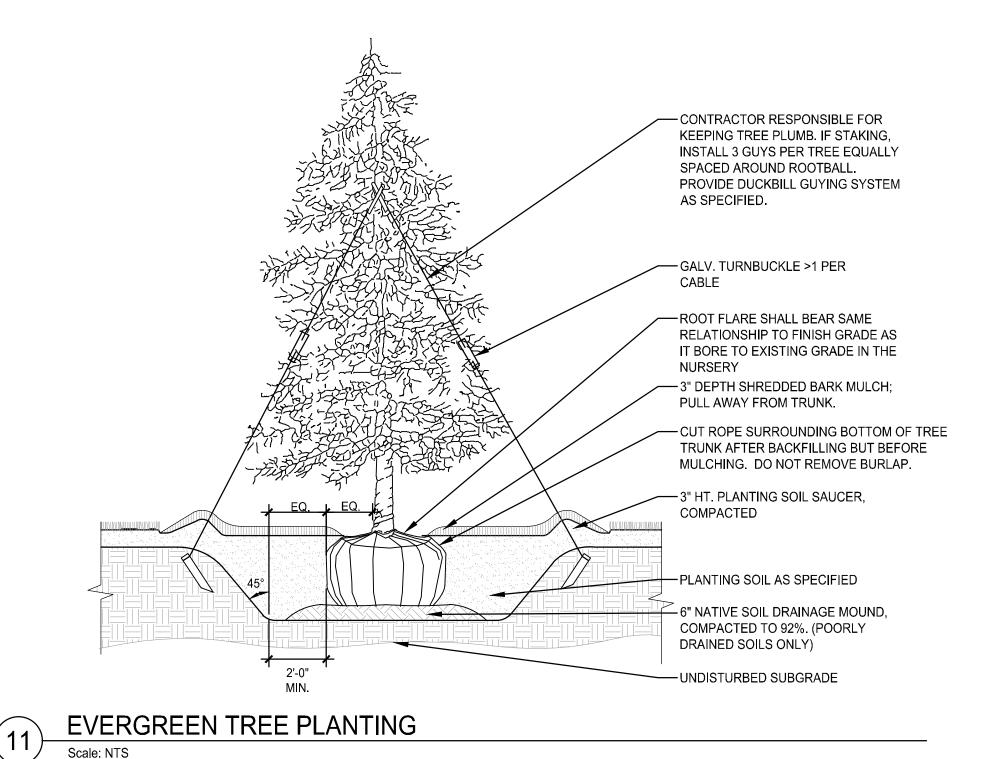


ALUMINUM LANDSCAPE EDGING

Scale: NTS

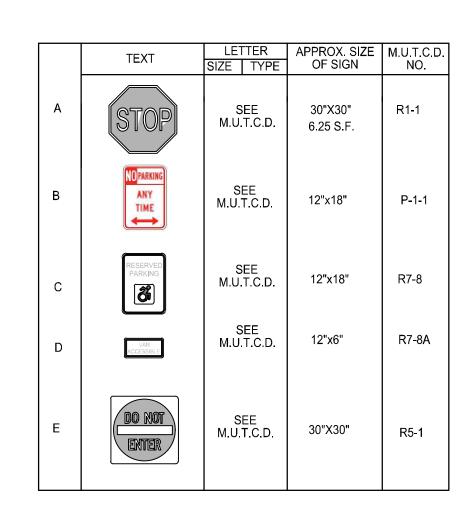

- NOTES: 1. ALL SIGNS SHALL CONFIRM WITH THE MOST CURRENT VERSION OF THE NYS MANUAL OF UNIFORM TRAFFIC CONTROL DEVICES (MUTCD) NYSDOT STANDARDS AND LOCAL CODE FOR SIZE, REFLECTIVITY AND HEIGHT.
- LOCATE SIGNS AS NOTED ON PLANS AND DETAILS. SHOP DRAWINGS REQUIRED FOR ALL SIGN PANELS, AND SHALL REFERENCE MUTCD / NYSDOT STANDARDS FOR GRAPHIC LAYOUT.

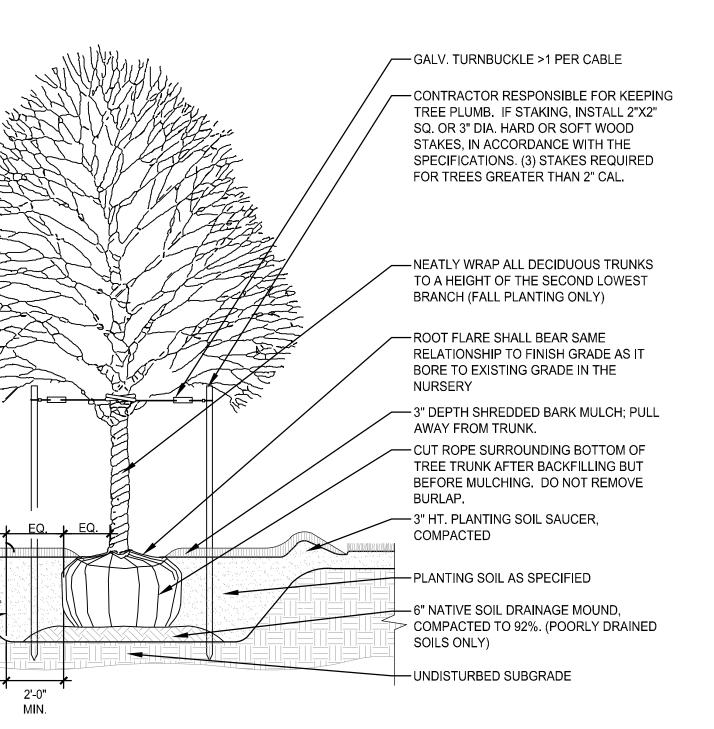


DECIDUOUS TREE PLANTING

10)


Scale: NTS

The LA GROUP Landscape Architecture & Engineering P.C. People. Purpose. Place. 40 Long Alley p: 518-587-8100 Saratoga Springs _____518-587-0180 NY 12866 www.thelagroup.com Unauthorized alteration or addition to this document is a violation of Section 7209 of the New York State Education Law. © the LA Group 2017 Prepared for: 1.1 KOA Kampgrounds of America, Inc. 550 N 31st Street Billings, MT 59101 Civil Engineer: North Woods Engineering 348 Lake Street Saranac Lake, NY 12983 Surveyor: Ausfeld & Waldruff 323 Clinton Street Schenectady, NY 12305 Surveyor: Adirondack Surveying PLLC PO Box 334 Jay, New York 12941 (518) 946-7571 Architect: Cushing Terrell 13 N. 23rd St. Billings, MT (406) 248-7455 Project Title: Lake Placid / Whiteface Mtn KOA Holiday - Riverside 5644 NYS Route 86 Wilmington, NY 12997 **ISSUED FOR:** SPECIAL USE PERMIT / SITE PLAN AND VARIANCE APPLICATIONS 2021110.02 Project No.: MI Design BAS Ch'k'd: MJT Drawn: 09/20/2022 Scale: Date[.] Description Drawing Title SITE DETAILS Drawing No. L-801

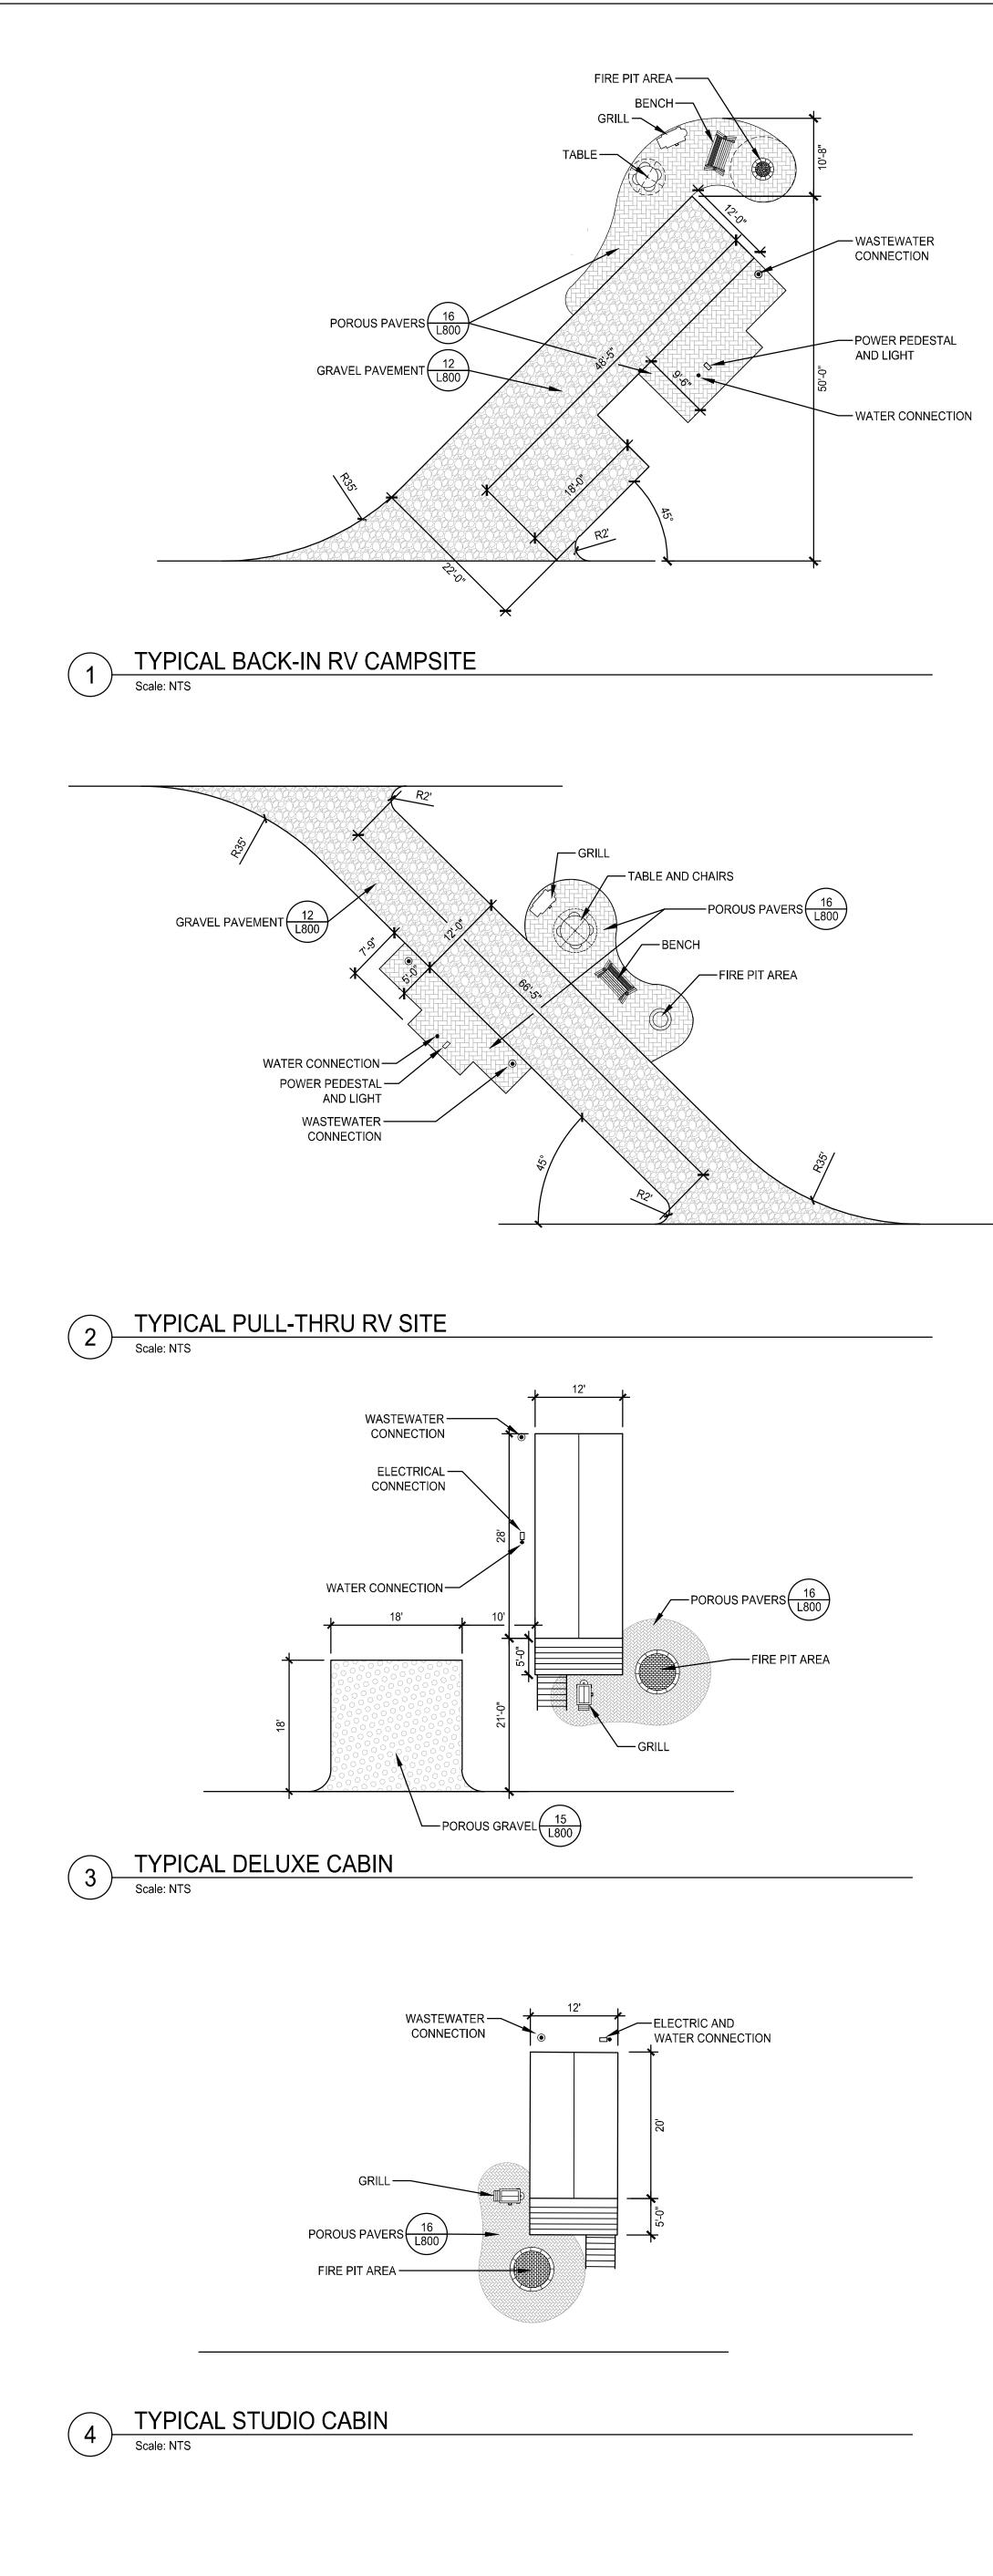


By: ate:



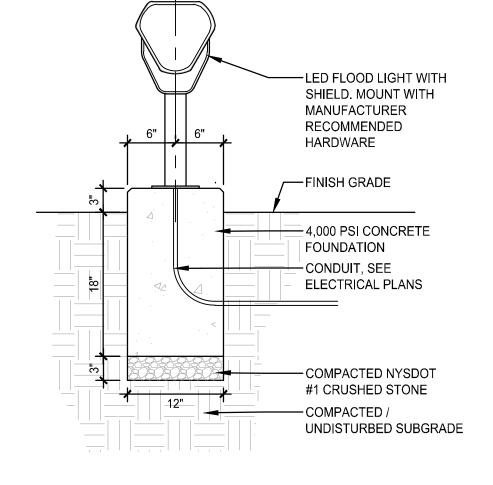




5 FLAGPOLE Scale: NTS

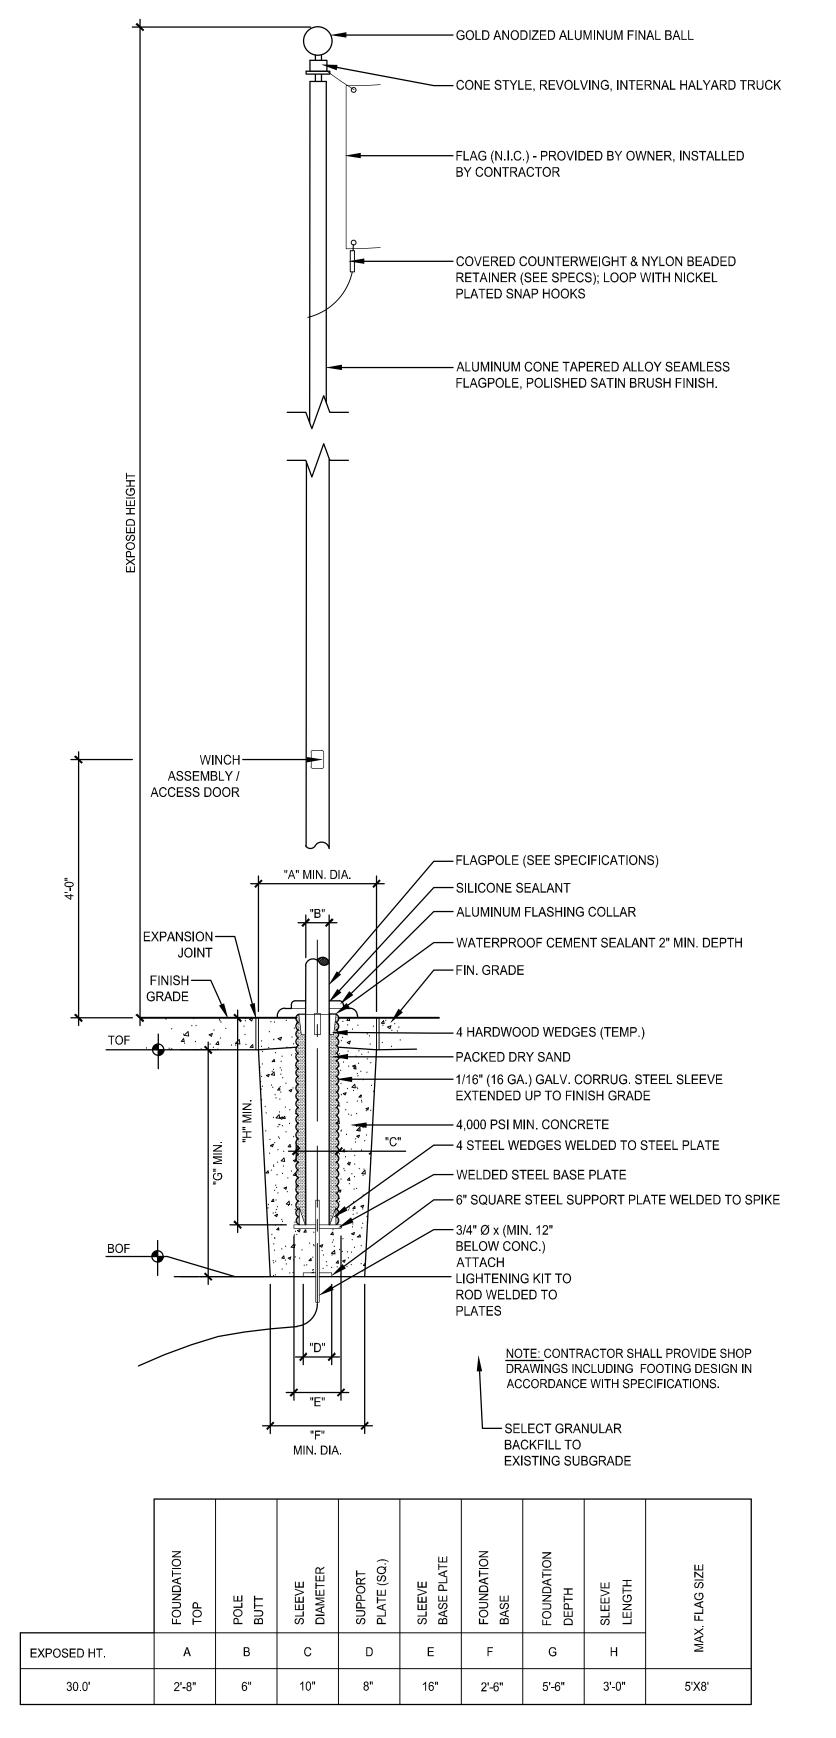




1. THE SIGN WILL BE 8' WIDE BY 10' IN HEIGHT. 2. IT WILL BE HELD IN PLACE BY WOODEN 4X4 POSTS WHICH WILL BE STAINED OR PAINTED. 3. THERE WILL BE DOWN LIGHTING OR SMALL LIGHTS POINTED AT THE SIGN TO ILLUMINATE IT.

FREE STANDING SIGN Scale: NTS

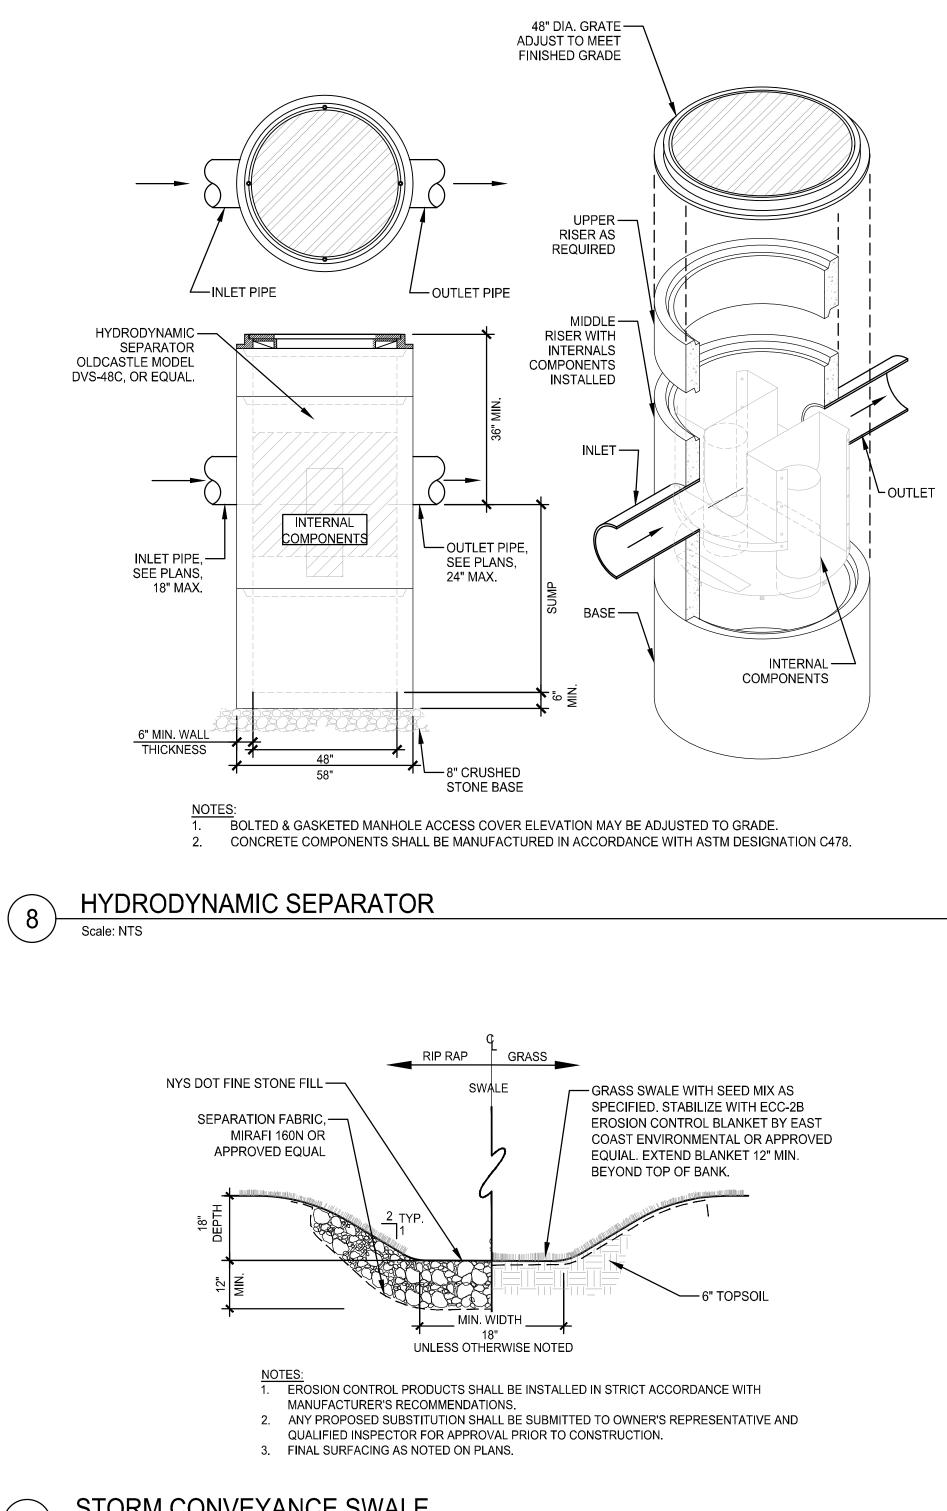

G The <mark>LA</mark> GROUP Landscape Architecture & Engineering P.C. People. Purpose. Place. 40 Long Alley p: 518-587-8100 Saratoga Springs ______518-587-0180 NY 12866 www.thelagroup.com Unauthorized alteration or addition to this document is a violation of Section 7209 of the New York State Education Law. © the LA Group 2017 Prepared for: 1.1 KOA Kampgrounds of America, Inc. 550 N 31st Street Billings, MT 59101 Civil Engineer: North Woods Engineering 348 Lake Street Saranac Lake, NY 12983 Surveyor: Ausfeld & Waldruff 323 Clinton Street Schenectady, NY 12305 Surveyor: Adirondack Surveying PLLC PO Box 334 Jay, New York 12941 (518) 946-7571 Architect: Cushing Terrell 13 N. 23rd St. Billings, MT (406) 248-7455 Project Title: Lake Placid / Whiteface Mtn KOA Holiday - Riverside 5644 NYS Route 86 Wilmington, NY 12997 **ISSUED FOR:** SPECIAL USE PERMIT / SITE PLAN AND VARIANCE APPLICATIONS 2021110.02 Project No.: MIT Design BAS Ch'k'd: MJT Drawn: 09/20/2022 Scale: Date: Description: Date Drawing Title SITE DETAILS Drawing No. L-802

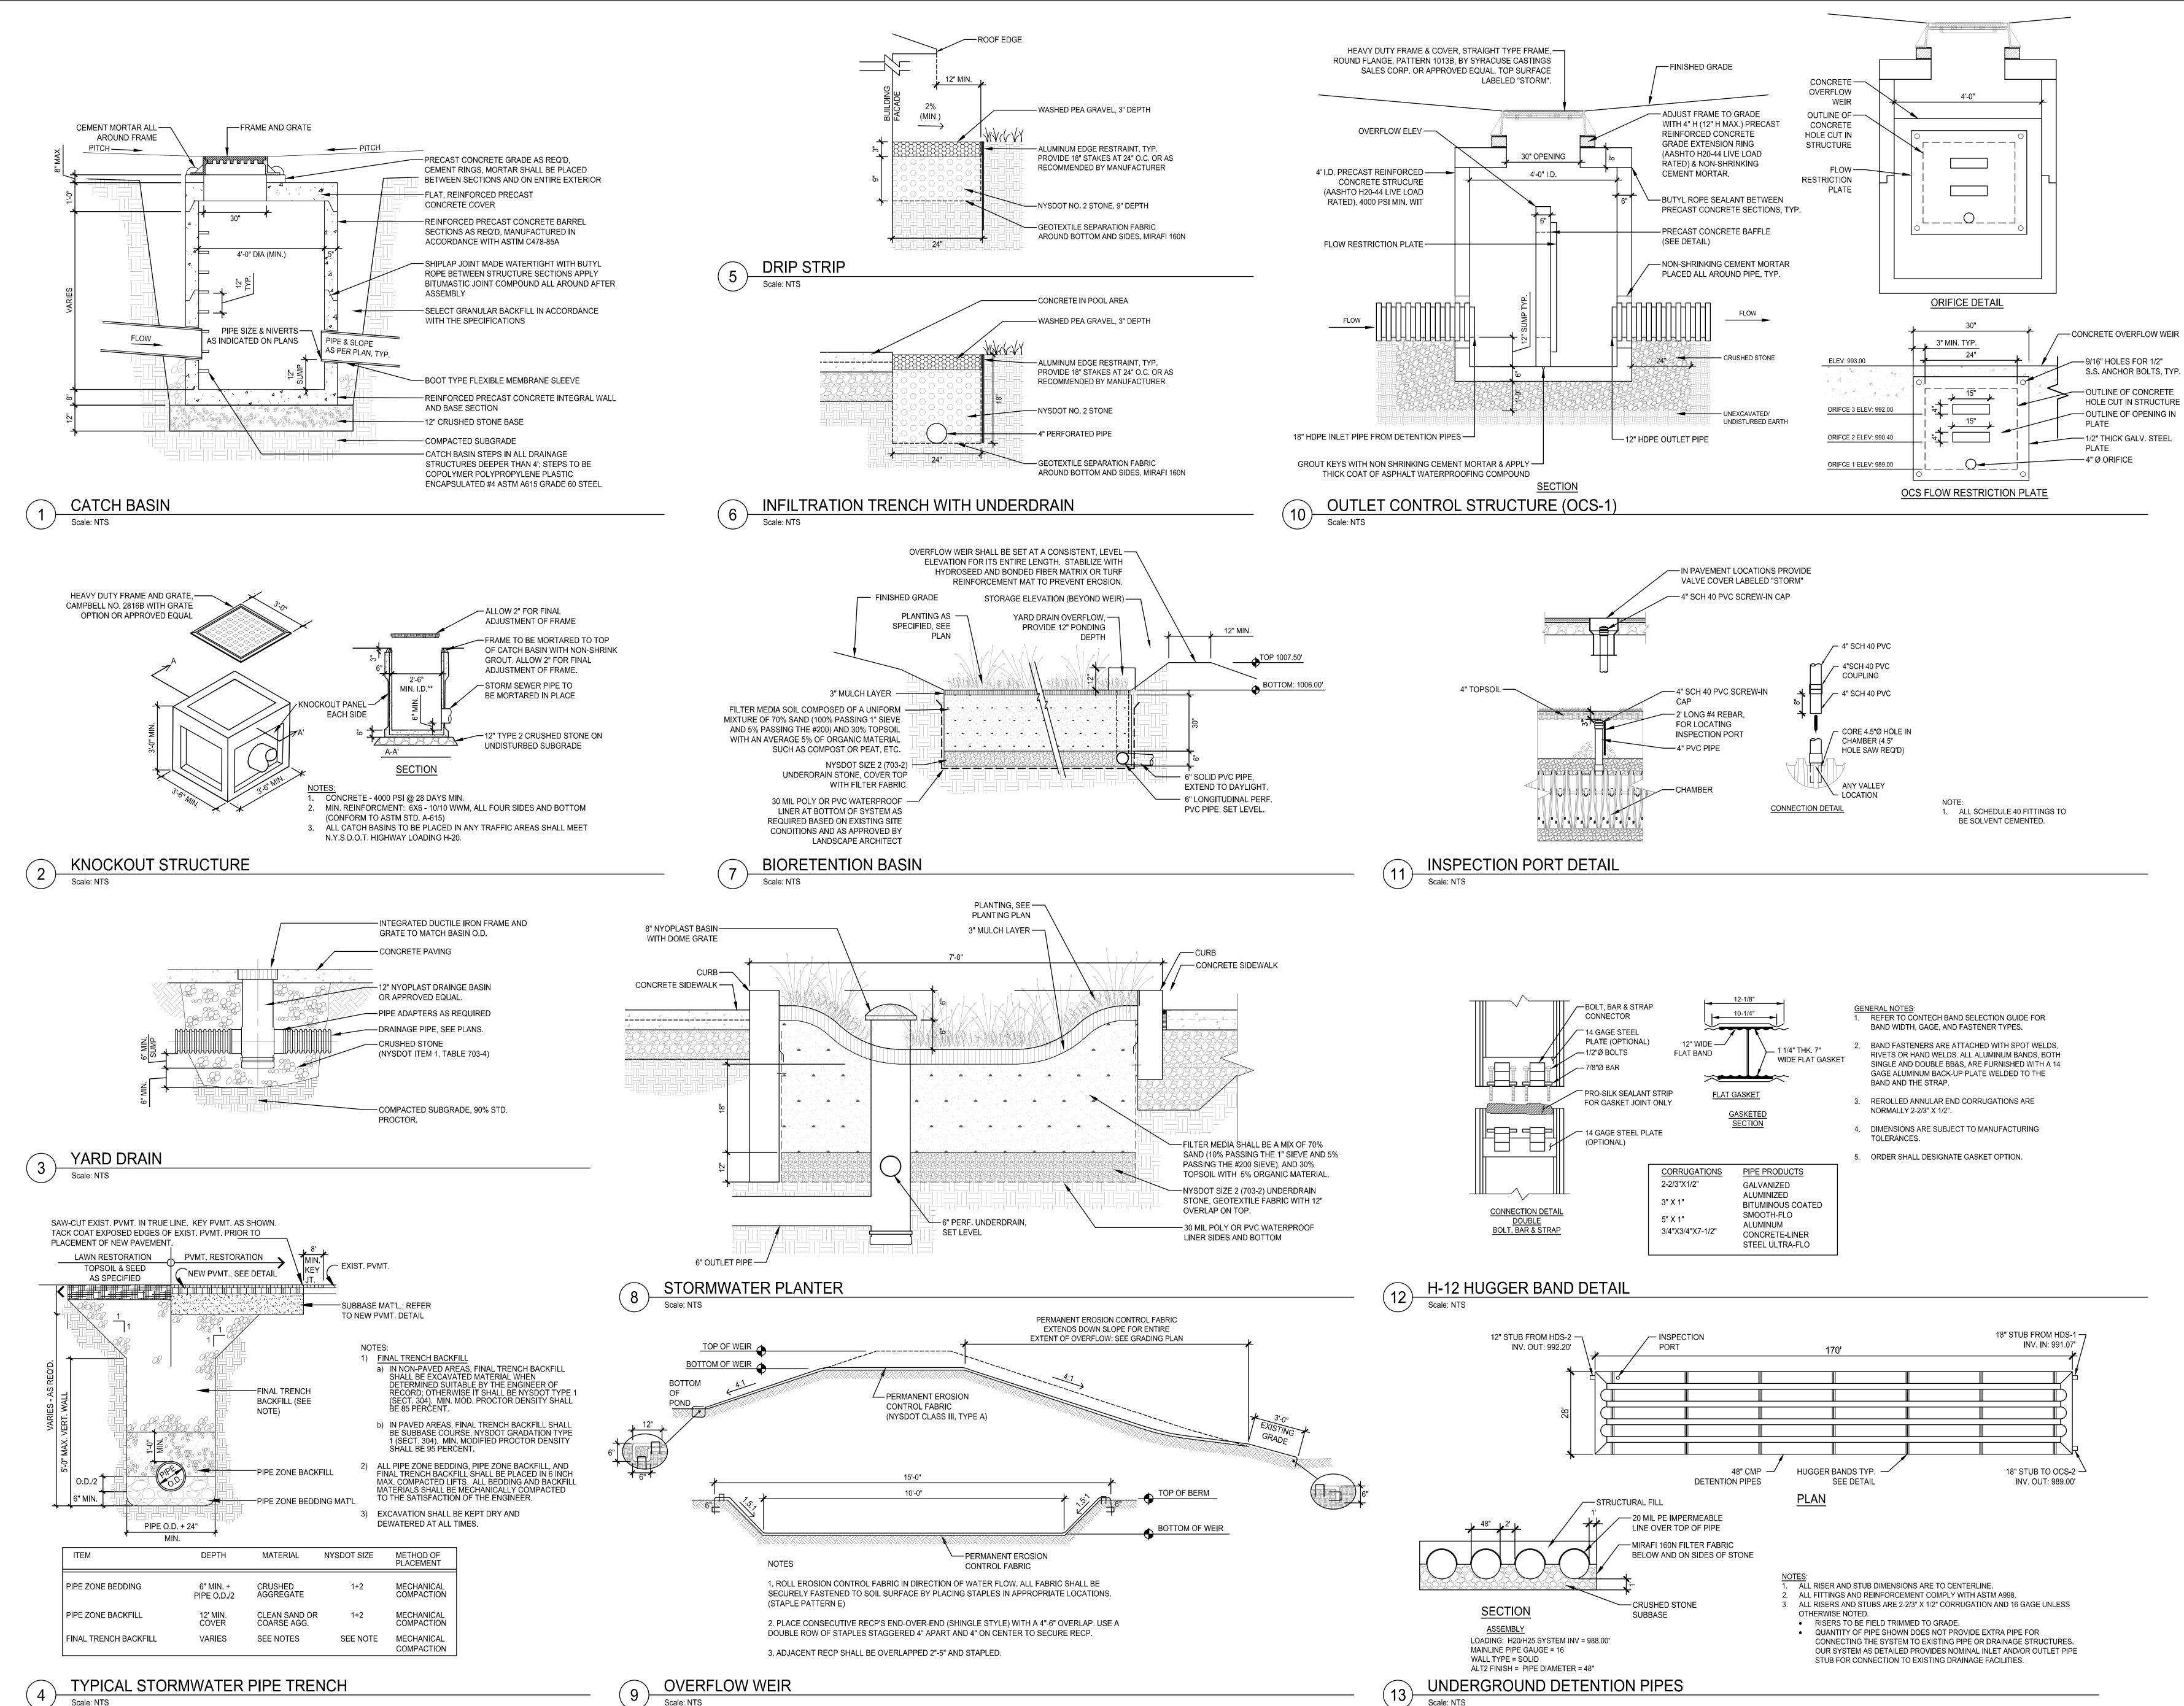

Landscape Architecture & Engineering P.C. People, Purpose, Place. 40 Long Alley p: 518-587-8100 Saratoga Springs ______518-587-0180 NY 12866 www.thelagroup.com Unauthorized alteration or addition to this document is a violation of Section 7209 of the New York State Education Law. © the LA Group 2017 Prepared for: 1.1 KOA Kampgrounds of America, Inc. 550 N 31st Street Billings, MT 59101 Civil Engineer: North Woods Engineering 348 Lake Street Saranac Lake, NY 12983 Surveyor: Ausfeld & Waldruff 323 Clinton Street Schenectady, NY 12305 Surveyor: Adirondack Surveying PLLC PO Box 334 Jay, New York 12941 (518) 946-7571 Architect: Cushing Terrell 13 N. 23rd St. Billings, MT (406) 248-7455 Project Title: Lake Placid / Whiteface Mtn KOA Holiday - Riverside 5644 NYS Route 86 Wilmington, NY 12997 **ISSUED FOR:** SPECIAL USE PERMIT / SITE PLAN AND VARIANCE APPLICATIONS 2021110.02 Project No.: MIT Desig BAS Ch'k'd: MJT Drawn: 09/20/2022 Scale Date[.] Description: Drawing Title SITE DETAILS Drawing No. L-803

The L

•	KNOWN AS RIVERSIDE" BY ADIRONDACK SURVEYING PLLC, DATED MAY 17, 2022. PRIOR TO COMMENCING ANY EXCAVATION WORK, THE CONTRACTOR SHALL CONTACT U.F.P.O. (1-800-962-7962) AND THE PROPER LOCAL AUTHORITIES OR RESPECTIVE UTILITY COMPANY HAVING JURISDICTION TO CONFIRM THE LOCATION OF ALL EXISTING UTILITIES BEFORE COMMENCING WORK. ANY
	COSTS INCURRED BY THE CONTRACTOR DUE TO FAILURE TO CONTACT THE PROPER AUTHORITIES SHALL BECOME THE RESPONSIBILITY OF THE CONTRACTOR. CONTRACTOR. PRIOR TO DEMOLITION, THE CONTRACTOR SHALL RETAIN THE SERVICES OF A UTILITY LOCATING SERVICE IN ACCORDANCE WITH SPECIFICATION, THAT
	SHALL BE RESPONSIBLE FOR LOCATING AND DOCUMENTING ALL UNDERGROUND UTILITIES.
	THE LOCATIONS OF ALL UNDERGROUND UTILITIES SHOWN ON THESE PLANS ARE DIAGRAMMATIC ONLY. CONTRACTOR SHALL COORDINATE LOCATION OF ALL UTILITIES (LINES, DUCTS, CONDUITS, SLEEVES, FOOTINGS, ETC.) WITH LOCATIONS OF PROPOSED LANDSCAPE ELEMENTS (WALLS, FENCE, FOOTINGS, TREE ROOTBALLS, PROPOSED LIGHTING FOOTINGS, ETC.). EXCAVATION REQUIRED WITHIN PROXIMITY OF UTILITY LINES SHALL BE DONE BY HAND. ANY DAMAGE AND INCURRED COSTS DUE TO FAILURE OF THE CONTRACTOR TO CONTACT THE PROPER AUTHORITIES SHALL BE BORNE BY THE CONTRACTOR
-	THE GENERAL CONTRACTOR SHALL VERIFY ALL SITE CONDITIONS IN THE FIELD AND REPORT ANY DISCREPANCY BETWEEN THE PLANS AND THE ACTUAL FIELD CONDITIONS TO THE OWNER.
	LIMIT OF WORK LINE IS NOTED ON DRAWINGS. CONTRACTOR IS RESPONSIBLE FOR ALL DAMAGE DUE TO OPERATIONS INSIDE AND OUTSIDE OF THE LIMITS OF WORK LINE. ANY AREAS OUTSIDE THE LIMIT OF WORK THAT ARE DISTURBED SHALL BE RESTORED TO ITS ORIGINAL CONDITION AT NO ADDITIONAL COST TO THE OWNER. CONTRACTOR SHALL MEET LINE AND GRADE OF EXISTING CONDITIONS AT LIMIT OF WORK LINE. IF NO LIMIT OF WORK IS SHOWN, THE PROPERTY LINE SHALL BE THE LIMIT OF WORK.
•	THE CONTRACTOR SHALL ESTABLISH PERMANENT BENCH MARKS. MAINTAIN ALL ESTABLISHED BOUNDS AND BENCH MARKS AND REPLACE ANY WHICH ARE DESTROYED OR DISTURBED.
•	CONTRACTOR SHALL EMPLOY SPECIAL CARE IN SCHEDULING CONSTRUCTION SO AS TO MAINTAIN EXISTING VEHICULAR TRAFFIC PATTERNS, AND MINIMIZE DISRUPTION TO SURROUNDING PEDESTRIAN TRAFFIC. CONTRACTOR SHALL EMPLOY SPECIAL CARE TO PROTECT SAFETY OF PEDESTRIANS INSIDE AND OUTSIDE OF THE LIMIT OF WORK LINE.
-	IT IS THE CONTRACTOR'S RESPONSIBILITY TO ENSURE ALL REQUIRED PERMITS FROM ALL JURISDICTIONS AFFECTED BY THIS WORK ARE IN PLACE PRIOF TO CONSTRUCTION. FOR PERMITS ALREADY ISSUED, CONTRACTOR SHALL OBTAIN COPIES OF PERMITS AND STRICTLY ADHERE TO PERMIT CONDITIONS. PERMITS THAT ARE OUTSTANDING SHALL BE SECURED BY THE CONTRACTOR AND COORDINATED WITH THE DIRECTOR'S REPRESENTATIVE.
).	ALL ALTERATIONS TO THESE DRAWINGS MADE IN THE FIELD DURING CONSTRUCTION SHALL BE RECORDED BY THE CONTRACTOR ON "RECORD DRAWINGS," AS SPECIFIED.
1.	STORAGE AREAS FOR THE GENERAL CONTRACTOR'S EQUIPMENT AND MATERIALS SHALL BE LOCATED WITHIN THE LIMITS OF WORK AS SHOWN ON THE PLANS OR AS APPROVED BY THE OWNER.
2.	SHOULD ANYTHING BE OMITTED FROM THE PLANS WHICH IS NECESSARY FOR A COMPLETE UNDERSTANDING OF THE WORK, OR SHALL ANY ERROR APPEAR IN THE VARIOUS INSTRUMENTS FURNISHED OR IN THE WORK BY OTHER CONTRACTORS AFFECTING THE WORK COVERED HEREBY, THE CONTRACTOR SHALL AND WILL PROMPTLY NOTIFY THE DIRECTOR'S REPRESENTATIVE, AND IN THE EVENT OF THE CONTRACTOR'S FAILURE TO DO SO, HE SHALL AND WILL MAKE GOOD OF ANY DAMAGE OR DEFECT IN HIS WORK CAUSED THEREBY.
3.	CONTRACTOR SHALL MAINTAIN THE INTEGRITY OF ALL EXISTING INFRASTRUCTURE FOR THE DURATION OF CONSTRUCTION. CONTRACTOR SHALL PROTECT AND SUSTAIN IN NORMAL SERVICE ALL EXISTING UTILITIES, STRUCTURES, EQUIPMENT, ROADWAYS AND DRIVEWAYS.
4.	THE CONTRACTOR SHALL BE RESPONSIBLE TO COORDINATE HIS EFFORTS OF DEMOLITION, REMOVALS AND OR RELOCATION WORK WITH ALL TRADES. CONSULT ALL DRAWINGS AND SPECIFICATIONS FOR ADDITIONAL COORDINATION REQUIREMENTS BEFORE COMMENCING CONSTRUCTION.
5.	CONTRACTOR TO COMPLY WITH ALL OSHA AND OTHER STATE AND LOCAL SAFETY REQUIREMENTS DURING CONSTRUCTION.
6.	CONTRACTOR SHALL MAINTAIN NECESSARY TRAFFIC CONTROL DEVICES, DRUMS, DELINEATORS, SIGNS, FENCES, AND BARRICADES IN ACCORDANCE WITH THE LATEST EDITION OF THE NATIONAL MUTCD WITH NYS SUPPLEMENT TO PROPERLY PROTECT WORK, EQUIPMENT, PERSONS, AND PROPERTY FROM DAMAGE. ALL DAILY TRAFFIC IN THE VICINITY OF THE SITE SHALL NOT BE IMPEDED.
31	TE PREPARATION & SITE DEMOLITION NOTES
	PRIOR TO CONSTRUCTION, CONTRACTOR SHALL ARRANGE PRE-CONSTRUCTION MEETING WITH DIRECTOR'S REPRESENTATIVE TO REVIEW ALL APPLICABLE PERMIT CONDITIONS, THE CONSTRUCTION PLANS AND GENERAL CONSTRUCTION SCHEDULE.
	CONTRACTOR SHALL REFER TO PROJECT STORMWATER POLLUTION PREVENTION PLAN (SWPPP) PRIOR TO MOBILIZATION / CONSTRUCTION. ALL WORK SHALL BE IN ACCORDANCE WITH THE PROJECT SWPPP. ALL EROSION CONTROL MEASURES SHALL BE IN PLACE PRIOR TO ANY EARTH DISTURBING ACTIVITIES. REFER TO PROJECT PLANS, NOTES AND DETAILS.
	THE CONTRACTOR'S ATTENTION IS DIRECTED TO THE GENERAL NOTES, UTILITY NOTES, SPECIFICATIONS, AND UTILITY LOCATING SERVICE REQUIREMENTS. NO WORK SHALL COMMENCE UNTIL UNDERGROUND UTILITIES WITHIN THE SITE HAVE BEEN IDENTIFIED AND LOCATED.
	ALL REFUSE, DEBRIS AND MISCELLANEOUS ITEMS TO BE REMOVED, THAT ARE NOT TO BE STOCKPILED FOR LATER USE ON THE PROJECT OR DELIVERED TO THE OWNER, SHALL BE LEGALLY DISPOSED OF OFF-SITE BY THE CONTRACTOR.
	CONTRACTOR SHALL STRIP AND STOCKPILE EXISTING TOPSOIL TO FULL DEPTH WITHIN LIMIT OF GRADING BEFORE COMMENCING EXCAVATION AND GRADING OPERATIONS. TOPSOIL SHALL NOT BE REMOVED FROM THE SITE, UNLESS APPROVED BY THE DIRECTOR'S REPRESENTATIVE.
	THE CONTRACTOR SHALL COORDINATE ALL ADJUSTMENT OR ABANDONMENT OF UTILITIES WITH THE RESPECTIVE UTILITY COMPANY AND PAY ALL ASSOCIATED COSTS.
	CONTRACTOR SHALL ABIDE BY ALL PERMITS THAT MAY BE REQUIRED FROM ALL JURISDICTIONS AFFECTED BY THIS WORK.
	CONTRACTOR SHALL PROTECT AND SUSTAIN IN NORMAL SERVICE ALL EXISTING UTILITIES, STRUCTURES, EQUIPMENT, ROADWAYS AND DRIVEWAYS.
	BEFORE ANY CLEARING IS DONE, THE CONTRACTOR SHALL ARRANGE A CONFERENCE ON THE SITE WITH THE LANDSCAPE ARCHITECT TO IDENTIFY TREES WHICH ARE TO BE PROTECTED OR REMOVED. DO NO CLEARING WITHOUT A CLEAR UNDERSTANDING OF EXISTING CONDITIONS TO BE PRESERVED.
١.	AT ALL LOCATIONS WHERE EXISTING PAVEMENT ABUTS NEW CONSTRUCTION, THE EDGE OF THE EXISTING PAVEMENT SHALL BE SAW CUT TO A CLEAN, SMOOTH AND SHARP EDGE AND PROTECTED UNTIL ABUTTING MATERIALS ARE INSTALLED.
	IT IS THE RESPONSIBILITY OF THE CONTRACTOR TO COORDINATE WITH THE DIRECTOR'S REPRESENTATIVE ON ALL MATERIALS TO BE REMOVED AND RECYCLED/DISPOSED OF OFF SITE. ALL HANDLING OF MATERIALS TO BE REMOVED, RECYCLED, OR DISPOSED OF MUST BE DONE SO IN A SAFE, LEGAL MANNER, IN ACCORDANCE WITH ALL LOCAL, COUNTY, STATE, FEDERAL AND ANY OTHER APPLICABLE REGULATIONS.
•	ALL ITEMS REQUIRING REMOVAL SHALL BE REMOVED TO FULL DEPTH, INCLUDING BASE MATERIAL AND FOOTINGS OR FOUNDATIONS, UNLESS OTHERWISE NOTED.
	EXISTING ITEMS INDICATED TO BE SALVAGED OR STOCKPILED SHALL BE CAREFULLY REMOVED AND STORED AS DIRECTED BY THE DIRECTOR'S REPRESENTATIVE.
).	EXISTING ITEMS INDICATED TO BE SALVAGED OR STOCKPILED SHALL BE CAREFULLY REMOVED AND STORED AS DIRECTED BY THE DIRECTOR'S REPRESENTATIVE. TREE, SHRUB AND VEGETATION REMOVAL SHALL INCLUDE THE FELLING, CUTTING, GRUBBING OUT OF ENTIRE ROOT SYSTEM AND SATISFACTORY OFF-SITE DISPOSAL OF ALL TREES, SHRUBS, STUMPS, VEGETATIVE AND EXTRANEOUS DEBRIS PRODUCED THROUGH THE REMOVAL OPERATIONS. PITS/HOLES REMAINING AFTER GRUBBING OPERATIONS SHALL BE BACKFILLED AND COMPACTED AS SPECIFIED.
	REPRESENTATIVE. TREE, SHRUB AND VEGETATION REMOVAL SHALL INCLUDE THE FELLING, CUTTING, GRUBBING OUT OF ENTIRE ROOT SYSTEM AND SATISFACTORY OFF-SITE DISPOSAL OF ALL TREES, SHRUBS, STUMPS, VEGETATIVE AND EXTRANEOUS DEBRIS PRODUCED THROUGH THE REMOVAL OPERATIONS.
2. 3. 4.	REPRESENTATIVE. TREE, SHRUB AND VEGETATION REMOVAL SHALL INCLUDE THE FELLING, CUTTING, GRUBBING OUT OF ENTIRE ROOT SYSTEM AND SATISFACTORY OFF-SITE DISPOSAL OF ALL TREES, SHRUBS, STUMPS, VEGETATIVE AND EXTRANEOUS DEBRIS PRODUCED THROUGH THE REMOVAL OPERATIONS. PITS/HOLES REMAINING AFTER GRUBBING OPERATIONS SHALL BE BACKFILLED AND COMPACTED AS SPECIFIED. THE CONTRACTOR IS RESPONSIBLE FOR VERIFYING EXISTING CONDITIONS AND PERFORMING ALL SITE DEMOLITION AND REMOVALS REQUIRED TO
3. 5.	REPRESENTATIVE. TREE, SHRUB AND VEGETATION REMOVAL SHALL INCLUDE THE FELLING, CUTTING, GRUBBING OUT OF ENTIRE ROOT SYSTEM AND SATISFACTORY OFF-SITE DISPOSAL OF ALL TREES, SHRUBS, STUMPS, VEGETATIVE AND EXTRANEOUS DEBRIS PRODUCED THROUGH THE REMOVAL OPERATIONS. PITS/HOLES REMAINING AFTER GRUBBING OPERATIONS SHALL BE BACKFILLED AND COMPACTED AS SPECIFIED. THE CONTRACTOR IS RESPONSIBLE FOR VERIFYING EXISTING CONDITIONS AND PERFORMING ALL SITE DEMOLITION AND REMOVALS REQUIRED TO FACILITATE PROPOSED CONSTRUCTION. FIELD VERIFY EXISTING UTILITIES AND RESPECTIVE CONNECTIONS AND REPORT FINDINGS TO DIRECTOR'S REPRESENTATIVE, UPON AUTHORIZATION, REMOVE AND DISPOSE FENCE AND UTILITIES AND ABANDON CONNECTION IN ACCORDANCE WITH CODES AND REQUIREMENTS OF AUTHORITIES HAVING
2. 3. 4. 6.	REPRESENTATIVE. TREE, SHRUB AND VEGETATION REMOVAL SHALL INCLUDE THE FELLING, CUTTING, GRUBBING OUT OF ENTIRE ROOT SYSTEM AND SATISFACTORY OFF-SITE DISPOSAL OF ALL TREES, SHRUBS, STUMPS, VEGETATIVE AND EXTRANEOUS DEBRIS PRODUCED THROUGH THE REMOVAL OPERATIONS. PITS/HOLES REMAINING AFTER GRUBBING OPERATIONS SHALL BE BACKFILLED AND COMPACTED AS SPECIFIED. THE CONTRACTOR IS RESPONSIBLE FOR VERIFYING EXISTING CONDITIONS AND PERFORMING ALL SITE DEMOLITION AND REMOVALS REQUIRED TO FACILITATE PROPOSED CONSTRUCTION. FIELD VERIFY EXISTING UTILITIES AND RESPECTIVE CONNECTIONS AND REPORT FINDINGS TO DIRECTOR'S REPRESENTATIVE, UPON AUTHORIZATION, REMOVE AND DISPOSE FENCE AND UTILITIES AND ABANDON CONNECTION IN ACCORDANCE WITH CODES AND REQUIREMENTS OF AUTHORITIES HAVING JURISDICTION, IF UTILITIES MUST REMAIN IN SERVICE, PROTECT AGAINST DAMAGE AND MAINTAIN INTEGRITY OF SYSTEM. AYOUT NOTES:
2. 3. 4. 6.	REPRESENTATIVE. TREE, SHRUB AND VEGETATION REMOVAL SHALL INCLUDE THE FELLING, CUTTING, GRUBBING OUT OF ENTIRE ROOT SYSTEM AND SATISFACTORY OFF-SITE DISPOSAL OF ALL TREES, SHRUBS, STUMPS, VEGETATIVE AND EXTRANEOUS DEBRIS PRODUCED THROUGH THE REMOVAL OPERATIONS. PITS/HOLES REMAINING AFTER GRUBBING OPERATIONS SHALL BE BACKFILLED AND COMPACTED AS SPECIFIED. THE CONTRACTOR IS RESPONSIBLE FOR VERIFYING EXISTING CONDITIONS AND PERFORMING ALL SITE DEMOLITION AND REMOVALS REQUIRED TO FACILITATE PROPOSED CONSTRUCTION. FIELD VERIFY EXISTING UTILITIES AND RESPECTIVE CONNECTIONS AND REPORT FINDINGS TO DIRECTOR'S REPRESENTATIVE, UPON AUTHORIZATION, REMOVE AND DISPOSE FENCE AND UTILITIES AND ABANDON CONNECTION IN ACCORDANCE WITH CODES AND REQUIREMENTS OF AUTHORITIES HAVING JURISDICTION, IF UTILITIES MUST REMAIN IN SERVICE, PROTECT AGAINST DAMAGE AND MAINTAIN INTEGRITY OF SYSTEM. ALL LINE AND GRADE INFORMATION SHALL BE LAID OUT BY A NEW YORK STATE LICENSED SURVEYOR ENGAGED BY THE CONTRACTOR .
2. 3. 1 . 5.	REPRESENTATIVE. TREE, SHRUB AND VEGETATION REMOVAL SHALL INCLUDE THE FELLING, CUTTING, GRUBBING OUT OF ENTIRE ROOT SYSTEM AND SATISFACTORY OFF-SITE DISPOSAL OF ALL TREES, SHRUBS, STUMPS, VEGETATIVE AND EXTRANEOUS DEBRIS PRODUCED THROUGH THE REMOVAL OPERATIONS. PITS/HOLES REMAINING AFTER GRUBBING OPERATIONS SHALL BE BACKFILLED AND COMPACTED AS SPECIFIED. THE CONTRACTOR IS RESPONSIBLE FOR VERIFYING EXISTING CONDITIONS AND PERFORMING ALL SITE DEMOLITION AND REMOVALS REQUIRED TO FACILITATE PROPOSED CONSTRUCTION. FIELD VERIFY EXISTING UTILITIES AND RESPECTIVE CONNECTIONS AND REPORT FINDINGS TO DIRECTOR'S REPRESENTATIVE, UPON AUTHORIZATION, REMOVE AND DISPOSE FENCE AND UTILITIES AND ABANDON CONNECTION IN ACCORDANCE WITH CODES AND REQUIREMENTS OF AUTHORITIES HAVING JURISDICTION, IF UTILITIES MUST REMAIN IN SERVICE, PROTECT AGAINST DAMAGE AND MAINTAIN INTEGRITY OF SYSTEM. AYOUT NOTES:
	REPRESENTATIVE. TREE, SHRUB AND VEGETATION REMOVAL SHALL INCLUDE THE FELLING, CUTTING, GRUBBING OUT OF ENTIRE ROOT SYSTEM AND SATISFACTORY OFF-SITE DISPOSAL OF ALL TREES, SHRUBS, STUMPS, VEGETATIVE AND EXTRANEOUS DEBRIS PRODUCED THROUGH THE REMOVAL OPERATIONS. PITS/HOLES REMAINING AFTER GRUBBING OPERATIONS SHALL BE BACKFILLED AND COMPACTED AS SPECIFIED. THE CONTRACTOR IS RESPONSIBLE FOR VERIFYING EXISTING CONDITIONS AND PERFORMING ALL SITE DEMOLITION AND REMOVALS REQUIRED TO FACILITATE PROPOSED CONSTRUCTION. FIELD VERIFY EXISTING UTILITIES AND RESPECTIVE CONNECTIONS AND REPORT FINDINGS TO DIRECTOR'S REPRESENTATIVE, UPON AUTHORIZATION, REMOVE AND DISPOSE FENCE AND UTILITIES AND ABANDON CONNECTION IN ACCORDANCE WITH CODES AND REQUIREMENTS OF AUTHORITIES HAVING JURISDICTION, IF UTILITIES MUST REMAIN IN SERVICE, PROTECT AGAINST DAMAGE AND MAINTAIN INTEGRITY OF SYSTEM. ALL LINE AND GRADE INFORMATION SHALL BE LAID OUT BY A NEW YORK STATE LICENSED SURVEYOR ENGAGED BY THE CONTRACTOR. ALL NEW WORK SHALL BE STAKED OUT PRIOR TO CONSTRUCTION. THE DIRECTOR'S REPRESENTATIVE SHALL BE NOTIFIED OF ANY DISCREPANCIES. FIELD ADJUSTMENTS MUST BE APPROVED BY THE DIRECTOR'S REPRESENTATIVE PRIOR TO CONSTRUCTION. ALL LINES AND DIMENSIONS ARE PARALLEL OR PERPENDICULAR TO THE LINES FROM WHICH THEY ARE MEASURED UNLESS OTHERWISE NOTED.
	REPRESENTATIVE. TREE, SHRUB AND VEGETATION REMOVAL SHALL INCLUDE THE FELLING, CUTTING, GRUBBING OUT OF ENTIRE ROOT SYSTEM AND SATISFACTORY OFF-SITE DISPOSAL OF ALL TREES, SHRUBS, STUMPS, VEGETATIVE AND EXTRANEOUS DEBRIS PRODUCED THROUGH THE REMOVAL OPERATIONS. PITS/HOLES REMAINING AFTER GRUBBING OPERATIONS SHALL BE BACKFILLED AND COMPACTED AS SPECIFIED. THE CONTRACTOR IS RESPONSIBLE FOR VERIFYING EXISTING CONDITIONS AND PERFORMING ALL SITE DEMOLITION AND REMOVALS REQUIRED TO FACILITATE PROPOSED CONSTRUCTION. FIELD VERIFY EXISTING UTILITIES AND RESPECTIVE CONNECTIONS AND REPORT FINDINGS TO DIRECTOR'S REPRESENTATIVE, UPON AUTHORIZATION, REMOVE AND DISPOSE FENCE AND UTILITIES AND ABANDON CONNECTION IN ACCORDANCE WITH CODES AND REQUIREMENTS OF AUTHORITIES HAVING JURISDICTION, IF UTILITIES MUST REMAIN IN SERVICE, PROTECT AGAINST DAMAGE AND MAINTAIN INTEGRITY OF SYSTEM. YOUT NOTES: ALL LINE AND GRADE INFORMATION SHALL BE LAID OUT BY A NEW YORK STATE LICENSED SURVEYOR ENGAGED BY THE CONTRACTOR. ALL NEW WORK SHALL BE STAKED OUT PRIOR TO CONSTRUCTION. THE DIRECTOR'S REPRESENTATIVE SHALL BE NOTIFIED OF ANY DISCREPANCIES. FIELD ADJUSTMENTS MUST BE APPROVED BY THE DIRECTOR'S REPRESENTATIVE PRIOR TO CONSTRUCTION.

6. ALL PROPOSED WALKS, PAVEMENTS, LIGHTS AND SITE IMPROVEMENTS SHALL BE STAKED IN THE FIELD FOR APPROVAL BY THE DIRECTOR'S

REPRESENTATIVE PRIOR TO CONSTRUCTION.

- 7. CONTRACTOR SHALL COORDINATE LOCATION OF ALL UTILITIES (LINES, DUCTS, CONDUITS, SLEEVES, FOOTINGS, ETC.) WITH LOCATIONS OF PROPOSED LANDSCAPE ELEMENTS (WALLS, FENCE, FOOTINGS, TREE ROOTBALLS, PROPOSED LIGHTING FOOTINGS, ETC.). CONTRACTOR SHALL REPORT ANY DISCREPANCIES TO DIRECTOR'S REPRESENTATIVE PRIOR TO CONTINUING WORK.
- 8. ALL EXISTING UTILITIES ARE SHOWN IN THEIR RELATIVE POSITION. CONTRACTOR IS RESPONSIBLE FOR VERIFYING THE VERTICAL & HORIZONTAL POSITION OF EXISTING UTILITIES PRIOR TO CONSTRUCTION.

OSION AND SEDIMENT CONTROL NOTES

THE CONTRACTOR'S ATTENTION IS DIRECTED TO THE REQUIREMENTS OF THE NEW YORK STATE DEPARTMENT OF ENVIRONMENTAL CONSERVATION NYSDEC) STATE POLLUTANT DISCHARGE ELIMINATION SYSTEM SPDES GENERAL PERMIT FOR STORMWATER DISCHARGES FROM CONSTRUCTION ACTIVITY GP-0-20-001. THE STORMWATER POLLUTION PREVENTION PLAN (SWPPP) DEVELOPED FOR THIS PROJECT IS IN ACCORDANCE WITH THE SENERAL PERMIT FOR STORMWATER DISCHARGES FROM CONSTRUCTION ACTIVITY.

ALL CONSTRUCTION SHALL BE IN STRICT ACCORDANCE WITH THE STORMWATER POLLUTION PREVENTION PLAN (SWPPP), AND GENERAL CONSTRUCTION SEQUENCING. PRIOR TO CONSTRUCTION, THE CONTRACTOR SHALL REVIEW THE PROJECT SWPPP FOR SPECIFIC REQUIREMENTS REGARDING EROSION AND SEDIMENT CONTROL AND STORMWATER MANAGEMENT. A COPY OF THE SWPPP MUST BE MAINTAINED ON THE PROJECT SITE IN AN ACCESSIBLE LOCATION AT ALL TIMES DURING CONSTRUCTION.

PRIOR TO ANY SITE WORK, ALL CONTRACTORS AND SUBCONTRACTORS RESPONSIBLE FOR CONSTRUCTION, REPAIR, AND MAINTENANCE OF ANY ROSION AND SEDIMENT CONTROLS OR STORMWATER DEVICES MUST SIGN/CERTIFY THE SWPPP AND IDENTIFY A 'TRAINED CONTRACTOR'.

PRIOR TO BEGINNING EARTHWORK ACTIVITY, THE CONTRACTOR SHALL SUBMIT A MOBILIZATION PLAN SHOWING PROPOSED STOCKPILE AND STAGING AREAS, HAUL/ACCESS ROADS, FIELD OFFICES AND EQUIPMENT STORAGE AREAS, AND A SCHEDULE DETAILING THE STAGING OF CONSTRUCTION TO THE QUALIFIED INSPECTOR (SWPPP INSPECTOR) AND DIRECTOR'S REPRESENTATIVE FOR APPROVAL.

THE CONTRACTOR SHALL NOT DISTURB MORE THAN (5) ACRES AT ANY ONE TIME WITHOUT PRIOR WRITTEN AUTHORIZATION FROM NYSDEC. ALL DISTURBED AREAS THAT DO NOT MEET THE DEFINITION OF "FINAL STABILIZATION" AS LISTED IN THE NYSDEC SPDES GENERAL PERMIT FOR STORMWATER DISCHARGES MUST BE INCLUDED WHEN CALCULATING THE TOTAL AREA DISTURBED AT ANY ONE TIME. FINAL STABILIZATION CAN INCLUDE CRUSHED STONE, PAVEMENT, OR SEEDED LAWN WITH A MINIMUM DENSITY OF 80% COVERAGE.

EROSION CONTROL DEVICES SHALL BE INSPECTED DAILY AND MAINTAINED TO ENSURE SATISFACTORY PERFORMANCE AND COMPLIANCE WITH THE SWPPP.

IT IS THE CONTRACTOR'S RESPONSIBILITY TO CHECK THE SWPPP FOR INSPECTION REPORTS, AND IMMEDIATELY MAKE REPAIRS AND CORRECTIONS NOTED. REMEDIATION WORK THAT IS REQUIRED AS A RESULT OF FAILING TO MAKE REPAIRS SHALL BE PERFORMED BY THE CONTRACTOR AT NO ADDITIONAL COST TO THE OWNER.

ANY CHANGES TO THE SWPPP PROPOSED BY THE CONTRACTOR MUST BE APPROVED BY THE QUALIFIED INSPECTOR AND INCORPORATED INTO THE SWPPP PRIOR TO IMPLEMENTATION.

ANY DEVIATIONS FROM OR CONSTRUCTION CONFLICTS WITH THE PROJECT SWPPP SHALL BE IMMEDIATELY REPORTED TO THE DIRECTOR'S REPRESENTATIVE. IF THE CONTRACTOR PROPOSES A REVISED STAGING, SEQUENCING AND/OR MOBILIZATION PLAN, A MODIFIED PLAN MUST BE SUBMITTED TO THE QUALIFIED INSPECTOR FOR APPROVAL.

THE CONTRACTOR SHALL INITIATE TEMPORARY AND PERMANENT STABILIZATION MEASURES AS SOON AS PRACTICABLE IN ACCORDANCE WITH THE SWPPP.

ALL DISTURBED AREAS SHALL BE STABILIZED IN ACCORDANCE WITH THE PLANS AND PROJECT SWPPP. IN ADDITION TO WHAT IS SHOWN ON PLANS, ANY SLOPES GREATER THAN 3:1 DISTURBED AS PART OF CONSTRUCTION SHALL BE STABILIZED IN ACCORDANCE WITH PROJECT DETAILS AND SWPPP. ROSION AND SEDIMENT CONTROL PROTECTIONS SHOWN ON THE PLANS REPRESENT THE MINIMUM MEASURES NECESSARY. ADDITIONAL MEASURES AND DEVICES MAY BE NEEDED DUE TO SITE SPECIFIC CONDITIONS OR CHANGING CONDITIONS DUE TO CONSTRUCTION, IN ORDER TO MAINTAIN COMPLIANCE WITH THE SWPPP AND GENERAL PERMIT, AND SHALL BE PROVIDED BY THE CONTRACTOR AT NO ADDITIONAL COST TO THE OWNER. EROSION AND SEDIMENT CONTROL PRACTICES SHALL BE MAINTAINED IN PLACE UNTIL CONSTRUCTION IS COMPLETED AND THE AREA IS STABILIZED AND

APPROVED BY THE QUALIFIED INSPECTOR.

PICAL EROSION AND SEDIMENT CONTROL SEQUENCING

TRUCTION ASSOCIATED WITH EROSION AND SEDIMENT CONTROL SHALL TYPICALLY PROCEED IN THE FOLLOWING SEQUENCE. ANY DEVIATIONS OR STMENTS TO THE TYPICAL SEQUENCING SHALL BE APPROVED BY THE QUALIFIED INSPECTOR. ALL EROSION AND SEDIMENT CONTROL PRACTICES SHALL PLEMENTED IN STRICT ACCORDANCE WITH THE PROJECT STORMWATER POLLUTION PREVENTION PLAN, AND CONTRACT DOCUMENTS.

CONSTRUCTION AND SITE PREPARATION PRE CONSTRUCTION MEETING - PROTOCOL MAY BE MODIFIED BY DESIGNATED QUALIFIED INSPECTOR.

DEFINE INSPECTION SCHEDULE, REVIEW STORMWATER POLLUTION PREVENTION PLAN. DEFINE LIMITS OF DISTURBANCE AND CLEARING LIMITS.

INSTALL TREE PROTECTION, AND WETLAND PROTECTION FENCE IF REQUIRED. INSTALL STABILIZED CONSTRUCTION ACCESS AND INITIAL STAGING AREAS.

INSTALL PERIMETER EROSION CONTROL INCLUDING SILT FENCE, FILTER SOCKS, ETC. CLEAR AND GRUB EXISTING VEGETATION.

PORARY RUNOFF AND DRAINAGE CONTROL TEMPORARILY STABILIZE CLEARED AREAS THAT WILL NOT BE DISTURBED WITHIN 14 DAYS. INSTALL ADDITIONAL PERIMETER EROSION CONTROL IN CLEARED AREAS AS NEEDED.

INSTALL INLET PROTECTION

HWORK AND SITE CONSTRUCTION STRIP & STOCKPILE TOPSOIL.

INSTALL INFRASTRUCTURE, INCLUDING CATCH BASINS WITH INLET PROTECTION, PIPING, AND PERMANENT DRAINAGE STRUCTURES. PERFORM ROUGH GRADING.

PORARY STABILIZATION OF WORK AREA

STABILIZE ALL BARE SOIL AREAS AS SOON AS PRACTICAL AND IN ACCORDANCE WITH THE SWPPP. INSPECT ALL PERIMETER EROSION CONTROL AND REPAIR AS NEEDED AND/OR DIRECTED.

INSTALL/REPAIR ALL INLET / OUTLET PROTECTION, AND STRUCTURAL STABILIZATION SUCH AS EROSION CONTROL BLANKETS, RIP RAP, AND CHECKDAMS. REMOVE SEDIMENT FROM TRAPPING DEVICES IN ACCORDANCE WITH THE SWPPP.

ANENT STABILIZATION PERFORM SOIL RESTORATION, DECOMPACTION AND FINISHED GRADING.

INSTALL SOD OR SEED. MULCH ALL GRASSED AREAS AND STABILIZE SLOPES IN ACCORDANCE WITH THE SWPPP AND CONTRACT DOCUMENTS. INSTALL PROPOSED PLANT MATERIALS. RECEIVE CERTIFICATION OF FINAL STABILIZATION FROM QUALIFIED INSPECTOR.

CLEAN ALL STORMWATER SYSTEMS OF SEDIMENT, TRASH, AND DEBRIS, REMOVE TEMPORARY EROSION AND SEDIMENT CONTROL MEASURES ONLY WHEN WORK AREAS ARE APPROVED AS STABILIZED BY THE QUALIFIED INSPECTOR.

ANTING NOTES:

ALL NEW PLANT MATERIAL SHALL CONFORM TO THE MINIMAL GUIDELINES ESTABLISHED BY THE AMERICAN STANDARD FOR NURSERY STOCK PUBLISHED BY THE AMERICAN ASSOCIATION OF NURSERYMEN, INC. ALL NEW MATERIAL FOR THE PROJECT SHALL BE OF SPECIMEN QUALITY UNLESS APPROVED OTHERWISE BY DIRECTOR'S REPRESENTATIVE.

ALL CONTAINER GROWN PLANTS SHALL BE PREMIUM QUALITY AND APPEAR 'FULL' IN HEIGHT AND WIDTH WITHIN THE POT. PLANTS DEEMED SUBSTANDARD IN SIZE SHALL BE REJECTED.

ALL NEW PLANTS TO BE BALLED AND BURLAPPED OR CONTAINER GROWN UNLESS OTHERWISE NOTED ON PLANT LIST.

THE CONTRACTOR SHALL SUPPLY ALL NEW PLANT MATERIAL IN QUANTITIES SUFFICIENT TO COMPLETE THE PLANTING SHOWN ON THE DRAWINGS. IN GENERAL, PLANT SPECIES SUBSTITUTIONS WILL NOT BE ACCEPTED. IF SPECIFIED MATERIAL IS NOT OBTAINABLE, CONTRACTOR SHALL SUBMIT PROOF OF NON-AVAILABILITY TO LANDSCAPE ARCHITECT ALONG WITH PROPOSED SUBSTITUTION. ANY PROPOSED SUBSTITUTIONS OF PLANT SPECIES SHALL BE MADE WITH PLANTS OF EQUIVALENT OVERALL FORM, HEIGHT, SIZE, BRANCHING HABIT, FLOWER, LEAF, COLOR, FRUIT AND CULTURE, AND ONLY AFTER WRITTEN APPROVAL OF THE LANDSCAPE ARCHITECT.

CONTRACTOR SHALL LOCATE AND VERIFY ALL EXISTING UTILITY LINES PRIOR TO PLANTING AND SHALL REPORT ANY CONFLICTS TO THE DIRECTOR'S REPRESENTATIVE.

NEW SHRUBS AND GROUND COVER SHALL BEAR THE SAME RELATIONSHIP TO GRADE AS IT BORE TO PREVIOUS GRADE. NO TREES SHALL BE PLANTED BEFORE ACCEPTANCE OF ROUGH GRADING.

ALL PLANT BEDS TO RECEIVE THREE INCHES (3") OF BARK MULCH UNLESS OTHERWISE SPECIFIED.

ALL AREAS PROPOSED FOR LAWN SEEDING SHALL RECEIVE A MINIMUM OF 6" OF SUITABLE TOPSOIL PRIOR TO SEEDING. ALL DISTURBED AREAS NOT SCHEDULED FOR PROPOSED WORK SHALL RECEIVE FOUR INCHES (4") OF SUITABLE TOPSOIL PRIOR TO SEEDING.

PLANTS SHALL BE DELIVERED ONLY AS THEY CAN BE INSTALLED IN REASONABLE TIME. ALL PLANTS ARE SUBJECT TO INSPECTION AT DELIVERY BY THE LANDSCAPE ARCHITECT/DIRECTOR'S REPRESENTATIVE.

IF DISCREPANCIES EXIST BETWEEN THE NUMBER OF PLANTS DRAWN ON THE PLANTING PLAN AND THE NUMBER OF PLANTS IN THE PLANT LIST, THE PLANTING PLAN SHALL GOVERN.

12. STAKE LOCATION OF ALL PROPOSED PLANTING FOR APPROVAL BY LANDSCAPE ARCHITECT PRIOR TO THE COMMENCEMENT OF PLANTING.

GRADING NOTES

- 3. PITCH EVENLY BETWEEN SPOT GRADES. ALL PAVED AREAS MUST PITCH TO DRAIN AT A MINIMUM SLOPE OF ONE-EIGHTH INCH (1/8") PER FOOT.

- 10. ALL EARTHWORK SHALL BE IN ACCORDANCE WITH THE GEOTECHNICAL REPORT AND SPECIFICATIONS.
- IRREGULAR SURFACE CHANGES.
- SHALL BE REPLACED IN KIND.
- 15. CONTRACTOR SHALL BLEND NEW EARTHWORK SMOOTHLY INTO EXISTING, PROVIDING VERTICAL CURVES OR ROUNDINGS AT ALL TOP AND BOTTOM OF
- SLOPES. 16. CONTRACTOR SHALL MAINTAIN THE INTEGRITY OF THE EXISTING DRAINAGE SYSTEM AT ALL TIMES. WHEN IT IS NECESSARY TO INTERRUPT THE
- DIRECTOR'S REPRESENTATIVE.
- (HORIZONTAL).

UTILITY NOTES

	THE CONTRACTOR'S ATTENTION IS D
1.1	LOCATIONS, EXTENT, AND SIZES MAPPING INFORMATION, AND SU IS THERE ANY GUARANTEE THAT SURVEY.
1.2	. THE CONTRACTOR SHALL CONT COMPANY HAVING JURISDICTION
1.3	THE CONTRACTOR SHALL COOR UNDERGROUND UTILITIES.
1.4	. THE CONTRACTOR SHALL RETAI
1.5	ANY COSTS INCURRED BY THE C RESPONSIBILITY OF THE CONTRA
	PRIOR TO CONSTRUCTION WATER AN ACCORDANCE WITH THEIR RESPECTI
•	CONTRACTOR SHALL COORDINATE A RESPECTIVE REQUIREMENTS.
•	ALL UTILITY INSTALLATIONS SHALL BI
•	ALL SEWERS, WATER MAINS, DRAINA ONLY AFTER THE SUBGRADE HAS BE
•	UTILITIES SHALL NOT BE BACKFILLED
	CONTRACTOR SHALL VERIFY EXACT I BUILDING PLANS PRIOR TO CONSTRU
	CONTRACTOR SHALL COORDINATE LO LANDSCAPE ELEMENTS (WALLS, FENO DISCREPANCIES TO THE DIRECTOR'S LOCATIONS SHALL BE BORNE BY THE
•	EXTEND DESIGNATED LIMIT OF WORK COORDINATE ANY WORK OUTSIDE TH
0.	CONTRACTOR SHALL PROTECT AND STHE DURATION OF CONSTRUCTION.

1. ALL PROPOSED GRADES SHALL BE SET IN THE FIELD BY A NEW YORK STATE LICENSED LAND SURVEYOR.

2. CONTRACTOR SHALL ESTABLISH PERMANENT SECONDARY BENCHMARKS PRIOR TO THE START OF CONSTRUCTION. ALL SECONDARY BENCHMARKS SHALL BE SO LOCATED THAT THEY WILL NOT BE DISTURBED BY CONSTRUCTION.

4. MAXIMUM CROSSPITCH OF ALL SIDEWALKS IS 2%. RAMPS SHALL NOT EXCEED 1 IN 12 OR 30' IN LENGTH. ANY DISCREPANCIES NOT ALLOWING THIS TO OCCUR SHALL BE REPORTED TO THE DIRECTOR'S REPRESENTATIVE PRIOR TO CONTINUING WORK.

5. SITE PAVEMENT SHALL MEET ALL BUILDING DOOR THRESHOLDS FLUSH AND IN ACCORDANCE WITH ADA GUIDELINES.

6. ALL PROPOSED TOP OF VERTICAL CURB ELEVATIONS ARE SIX INCHES (6") ABOVE BOTTOM OF CURB UNLESS SHOWN OTHERWISE.

7. WHERE NEW PAVING MEETS EXISTING PAVING, NEW PAVING SHALL MEET THE LINE AND GRADE OF THE EXISTING PAVING.

8. SET CATCH BASIN AND DROP INLET RIMS TO DRAIN SURROUNDING AREAS AND AT SAME PITCH AS SLOPING PAVEMENT. IF STRUCTURE IS SHOWN ADJACENT TO CURB, SET GRATE TIGHT TO FACE OF CURB.

EXCAVATION REQUIRED WITHIN 3 FEET OF EXISTING UTILITY LINES SHALL BE DONE BY HAND. CONTRACTOR SHALL REPAIR ANY DAMAGE TO EXISTING UTILITY LINES OR STRUCTURES INCURRED DURING CONSTRUCTION OPERATIONS AT NO ADDITIONAL COST TO OWNER.

11. GRADE AREAS ADJACENT TO BUILDING LINES TO DRAIN AWAY FROM STRUCTURE AND PREVENT PONDING. FINISH SURFACES SHALL BE FREE FROM

12. EXCAVATION REQUIRED WITHIN DRIP LINE OF TREES DESIGNATED TO REMAIN SHALL BE DONE BY HAND. PLANT MATERIALS DAMAGED BY CONTRACTOR

13. SLOPE SIDES OF EXCAVATIONS TO COMPLY WITH LOCAL CODES AND ORDINANCES HAVING JURISDICTION AND OSHA REGULATIONS, MAINTAIN SIDE SLOPES OF EXCAVATIONS IN A SAFE CONDITION UNTIL COMPLETION OF BACKFILLING.

14. THE GENERAL CONTRACTOR SHALL MAINTAIN OR ADJUST TO NEW FINISH GRADE AS NECESSARY ALL UTILITY AND SITE STRUCTURES SUCH AS LIGHT POLES, SIGN POLES, MAN HOLES, CATCH BASINS, HAND HOLES, WATER AND GAS GATES, HYDRANTS, ETC., FROM MAINTAINED UTILITY AND SITE SYSTEMS UNLESS OTHERWISE NOTED ON THE UTILITY DRAWINGS OR AS DIRECTED BY THE DIRECTOR'S REPRESENTATIVE.

EXISTING DRAINAGE PATTERNS AND/OR UTILITIES, PROVIDE TEMPORARY FACILITIES UNTIL WORK IS PERMANENTLY STABILIZED AND APPROVED BY

17. THE SIDES OF ANY NEW CUT AND/OR FILL SLOPES SHALL BE CONSTRUCTED W/ITH SLOPES NO STEEPER THAN 1 FOOT (VERTICAL) OVER 2 FOOT

ION IS DIRECTED TO THE FOLLOWING UTILITY LOCATING REQUIREMENTS:

D SIZES OF OVERHEAD AND UNDERGROUND UTILITIES AND SUBSTRUCTURES HAVE BEEN DETERMINED FROM RECORD , AND SUPPLEMENTED BY DATA OBTAINED IN THE FIELD. THE ACCURACY OF THIS UTILITY DATA IS NOT GUARANTEED, NOR EE THAT ALL EXISTING UTILITIES AND SUBSTRUCTURES, WHETHER FUNCTIONAL OR ABANDONED, ARE SHOWN ON THE

CONTACT DIG SAFELY NEW YORK (800) 962-7962 AND THE PROPER LOCAL AUTHORITIES OR RESPECTIVE UTILITY SDICTION TO CONFIRM THE LOCATION OF ALL EXISTING UTILITIES BEFORE COMMENCING WORK. $_$ COORDINATE WITH THE DIRECTOR'S REPRESENTATIVE FOR ADDITIONAL INFORMATION ON THE LOCATION OF EXISTING

RETAIN THE SERVICES OF A UTILITY LOCATING SERVICE IN ACCORDANCE WITH PROJECT SPECIFICATIONS.

BY THE CONTRACTOR DUE TO FAILURE TO COORDINATE AND CONTACT THE PROPER AUTHORITIES SHALL BECOME THE CONTRACTOR.

ATER AND SEWER CONNECTIONS SHALL BE REVIEWED AND APPROVED BY THE THE AUTHORITY HAVING JURISDICTION IN ESPECTIVE REQUIREMENTS.

DINATE ALL REQUIRED UTILITY INSPECTIONS BY THE AUTHORITY HAVING JURISDICTION IN ACCORDANCE WITH THEIR

SHALL BE IN ACCORDANCE WITH ALL REGULATORY, LOCAL MUNICIPAL AND BUILDING CODE REQUIREMENTS DRAINAGE STRUCTURES AND OTHER UNDERGROUND FACILITIES, TOGETHER WITH APPURTENANCES, SHALL BE INSTALLED HAS BEEN ESTABLISHED AND INSPECTED.

KFILLED UNTIL INSPECTED AND APPROVED BY INSPECTING ENGINEER.


EXACT LOCATIONS OF UTILITY STUBS AND FOOTING DRAINS FOR BUILDING CONNECTIONS WITH THE ARCHITECTURAL ONSTRUCTION. AND REPORT DISCREPANCIES TO DIRECTOR'S REPRESENTATIVE.


DINATE LOCATION OF ALL UTILITIES (LINES, DUCTS, CONDUITS, SLEEVES, FOOTINGS, ETC.) WITH LOCATIONS OF PROPOSED LS, FENCE, FOOTINGS, TREE ROOTBALLS, PROPOSED LIGHTING FOOTINGS, ETC.) AND IMMEDIATELY REPORT ANY CTOR'S REPRESENTATIVE, ANY DAMAGE AND INCURRED COSTS DUE TO FAILURE OF THE CONTRACTOR TO VERIFY UTILITY E BY THE CONTRACTOR.


F WORK AS NECESSARY TO ACCOMPLISH SITE UTILITY WORK AS REQUIRED BY THESE DRAWINGS AND SPECIFICATIONS. TSIDE THE LIMIT OF WORK WITH DIRECTOR'S REPRESENTATIVE.


CT AND SUSTAIN IN NORMAL SERVICE ALL EXISTING UTILITIES, STRUCTURES, EQUIPMENT ROADWAYS AND DRIVEWAYS FOR

Landscape Architecture & Engineering P.C People. Purpose. Place 40 Long Alley p: 518-587-8100 Saratoga Springs ______518-587-0180 NY 12866 www.thelagroup.com Unauthorized alteration or addition to this document is a violation of Section 7209 of the New York State Education Law. © the LA Group 2017 Prepared for: 1.1 KOA Kampgrounds of America, Inc. 550 N 31st Street Billings, MT 59101 Civil Engineer: North Woods Engineering 348 Lake Street Saranac Lake, NY 12983 Surveyor: Ausfeld & Waldruff 323 Clinton Street Schenectady, NY 12305 Surveyor: Adirondack Surveying PLLC PO Box 334 Jay, New York 12941 (518) 946-7571 Architect: Cushing Terrell 13 N. 23rd St. Billings, MT (406) 248-7455 Project Title: Lake Placid / Whiteface Mtn KOA Holiday - Riverside 5644 NYS Route 86 Wilmington, NY 12997 ISSUED FOR: SPECIAL USE PERMIT / SITE PLAN AND VARIANCE APPLICATIONS 2021110.02 Project No.: ME Design BAS Ch'k'd: MJ Drawn: 9/20/2022 Scale: 1"=40' Date: Description: Date: Drawing Title NOTES Drawing No. L-804

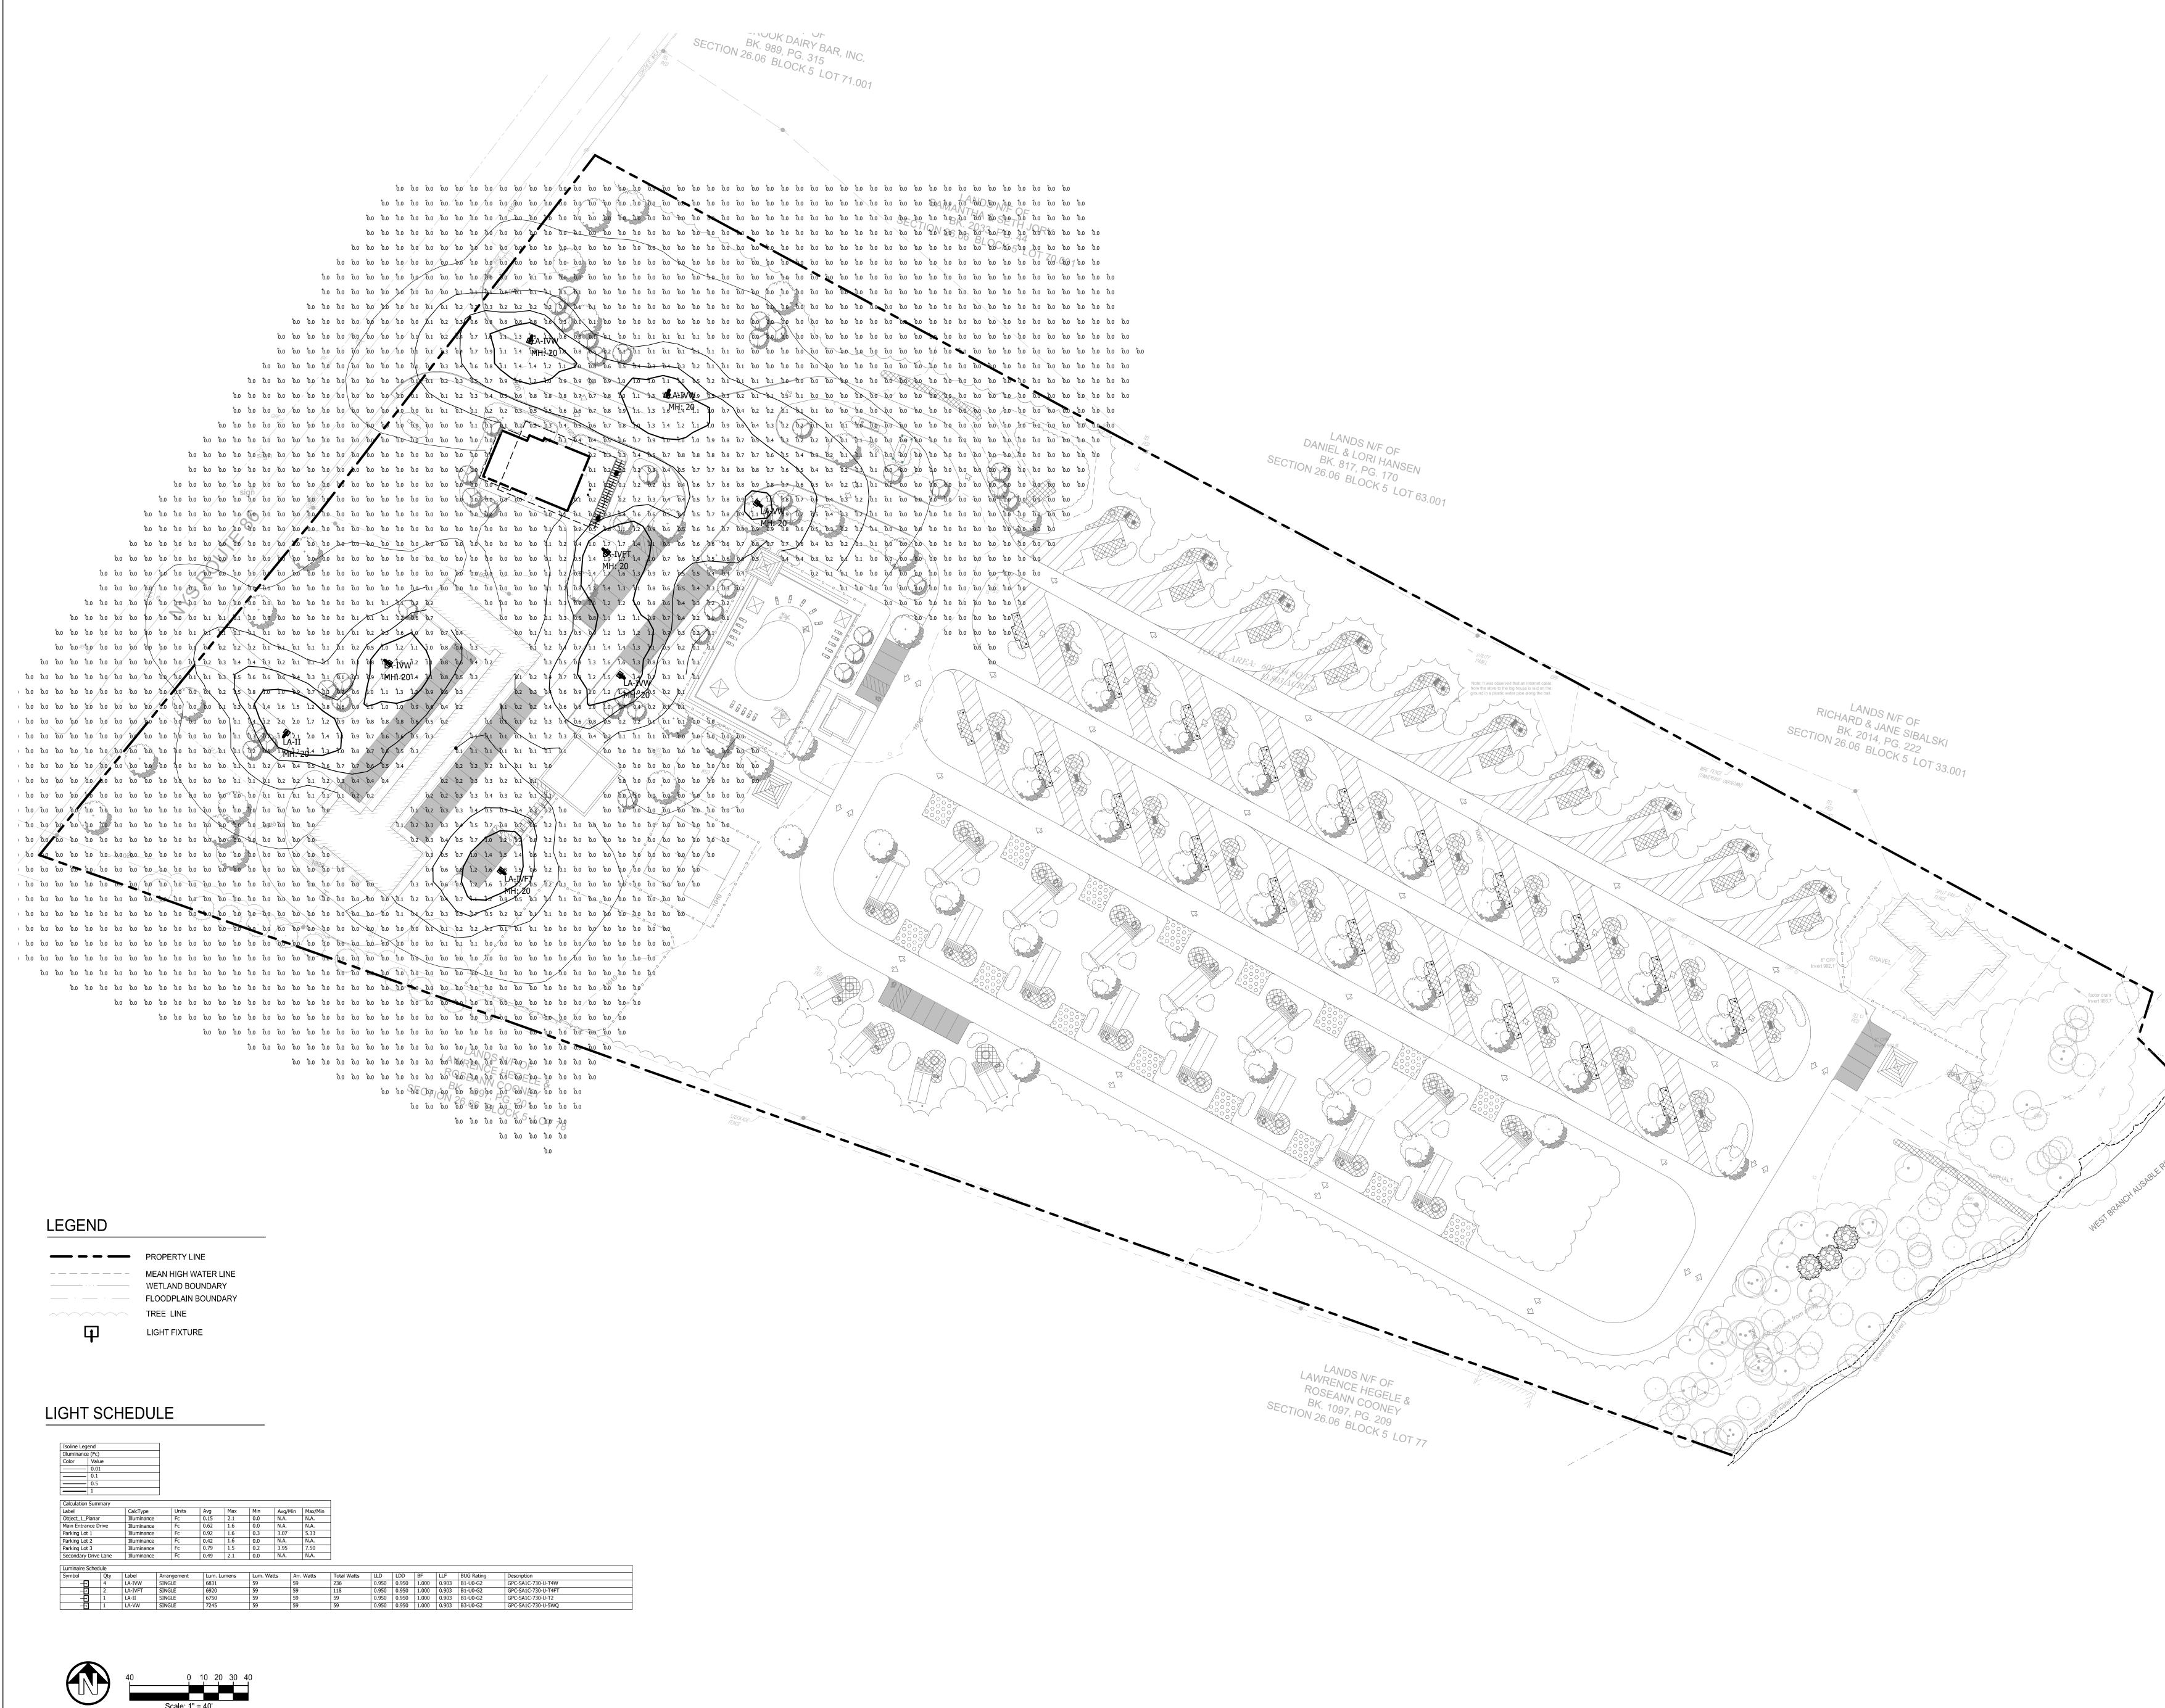

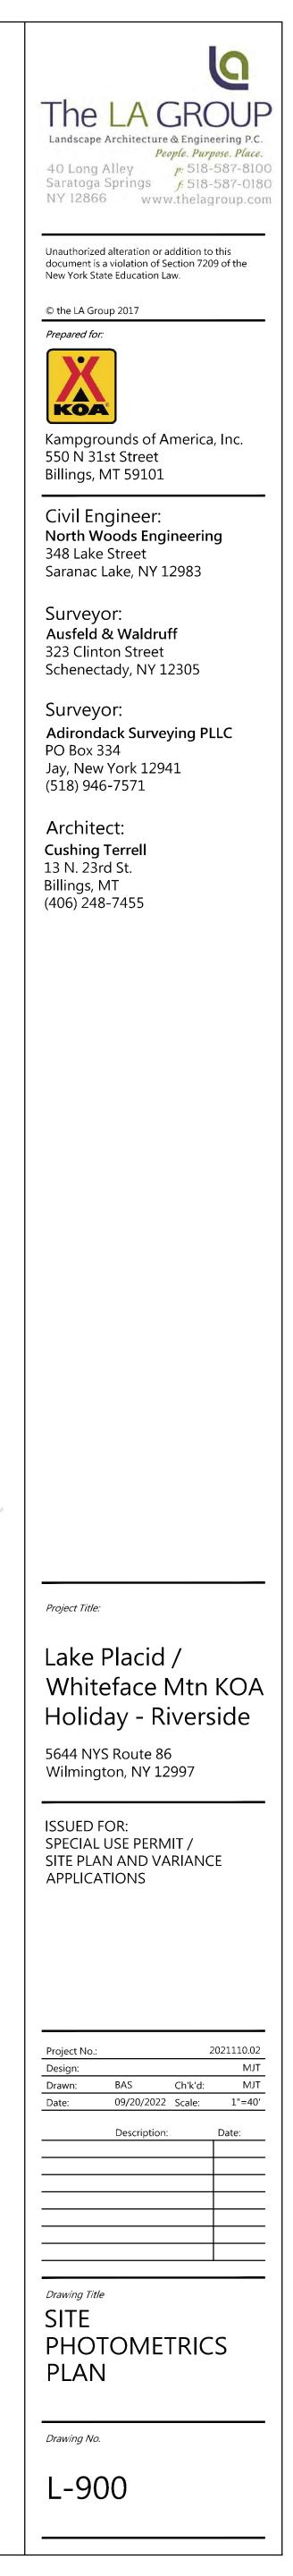

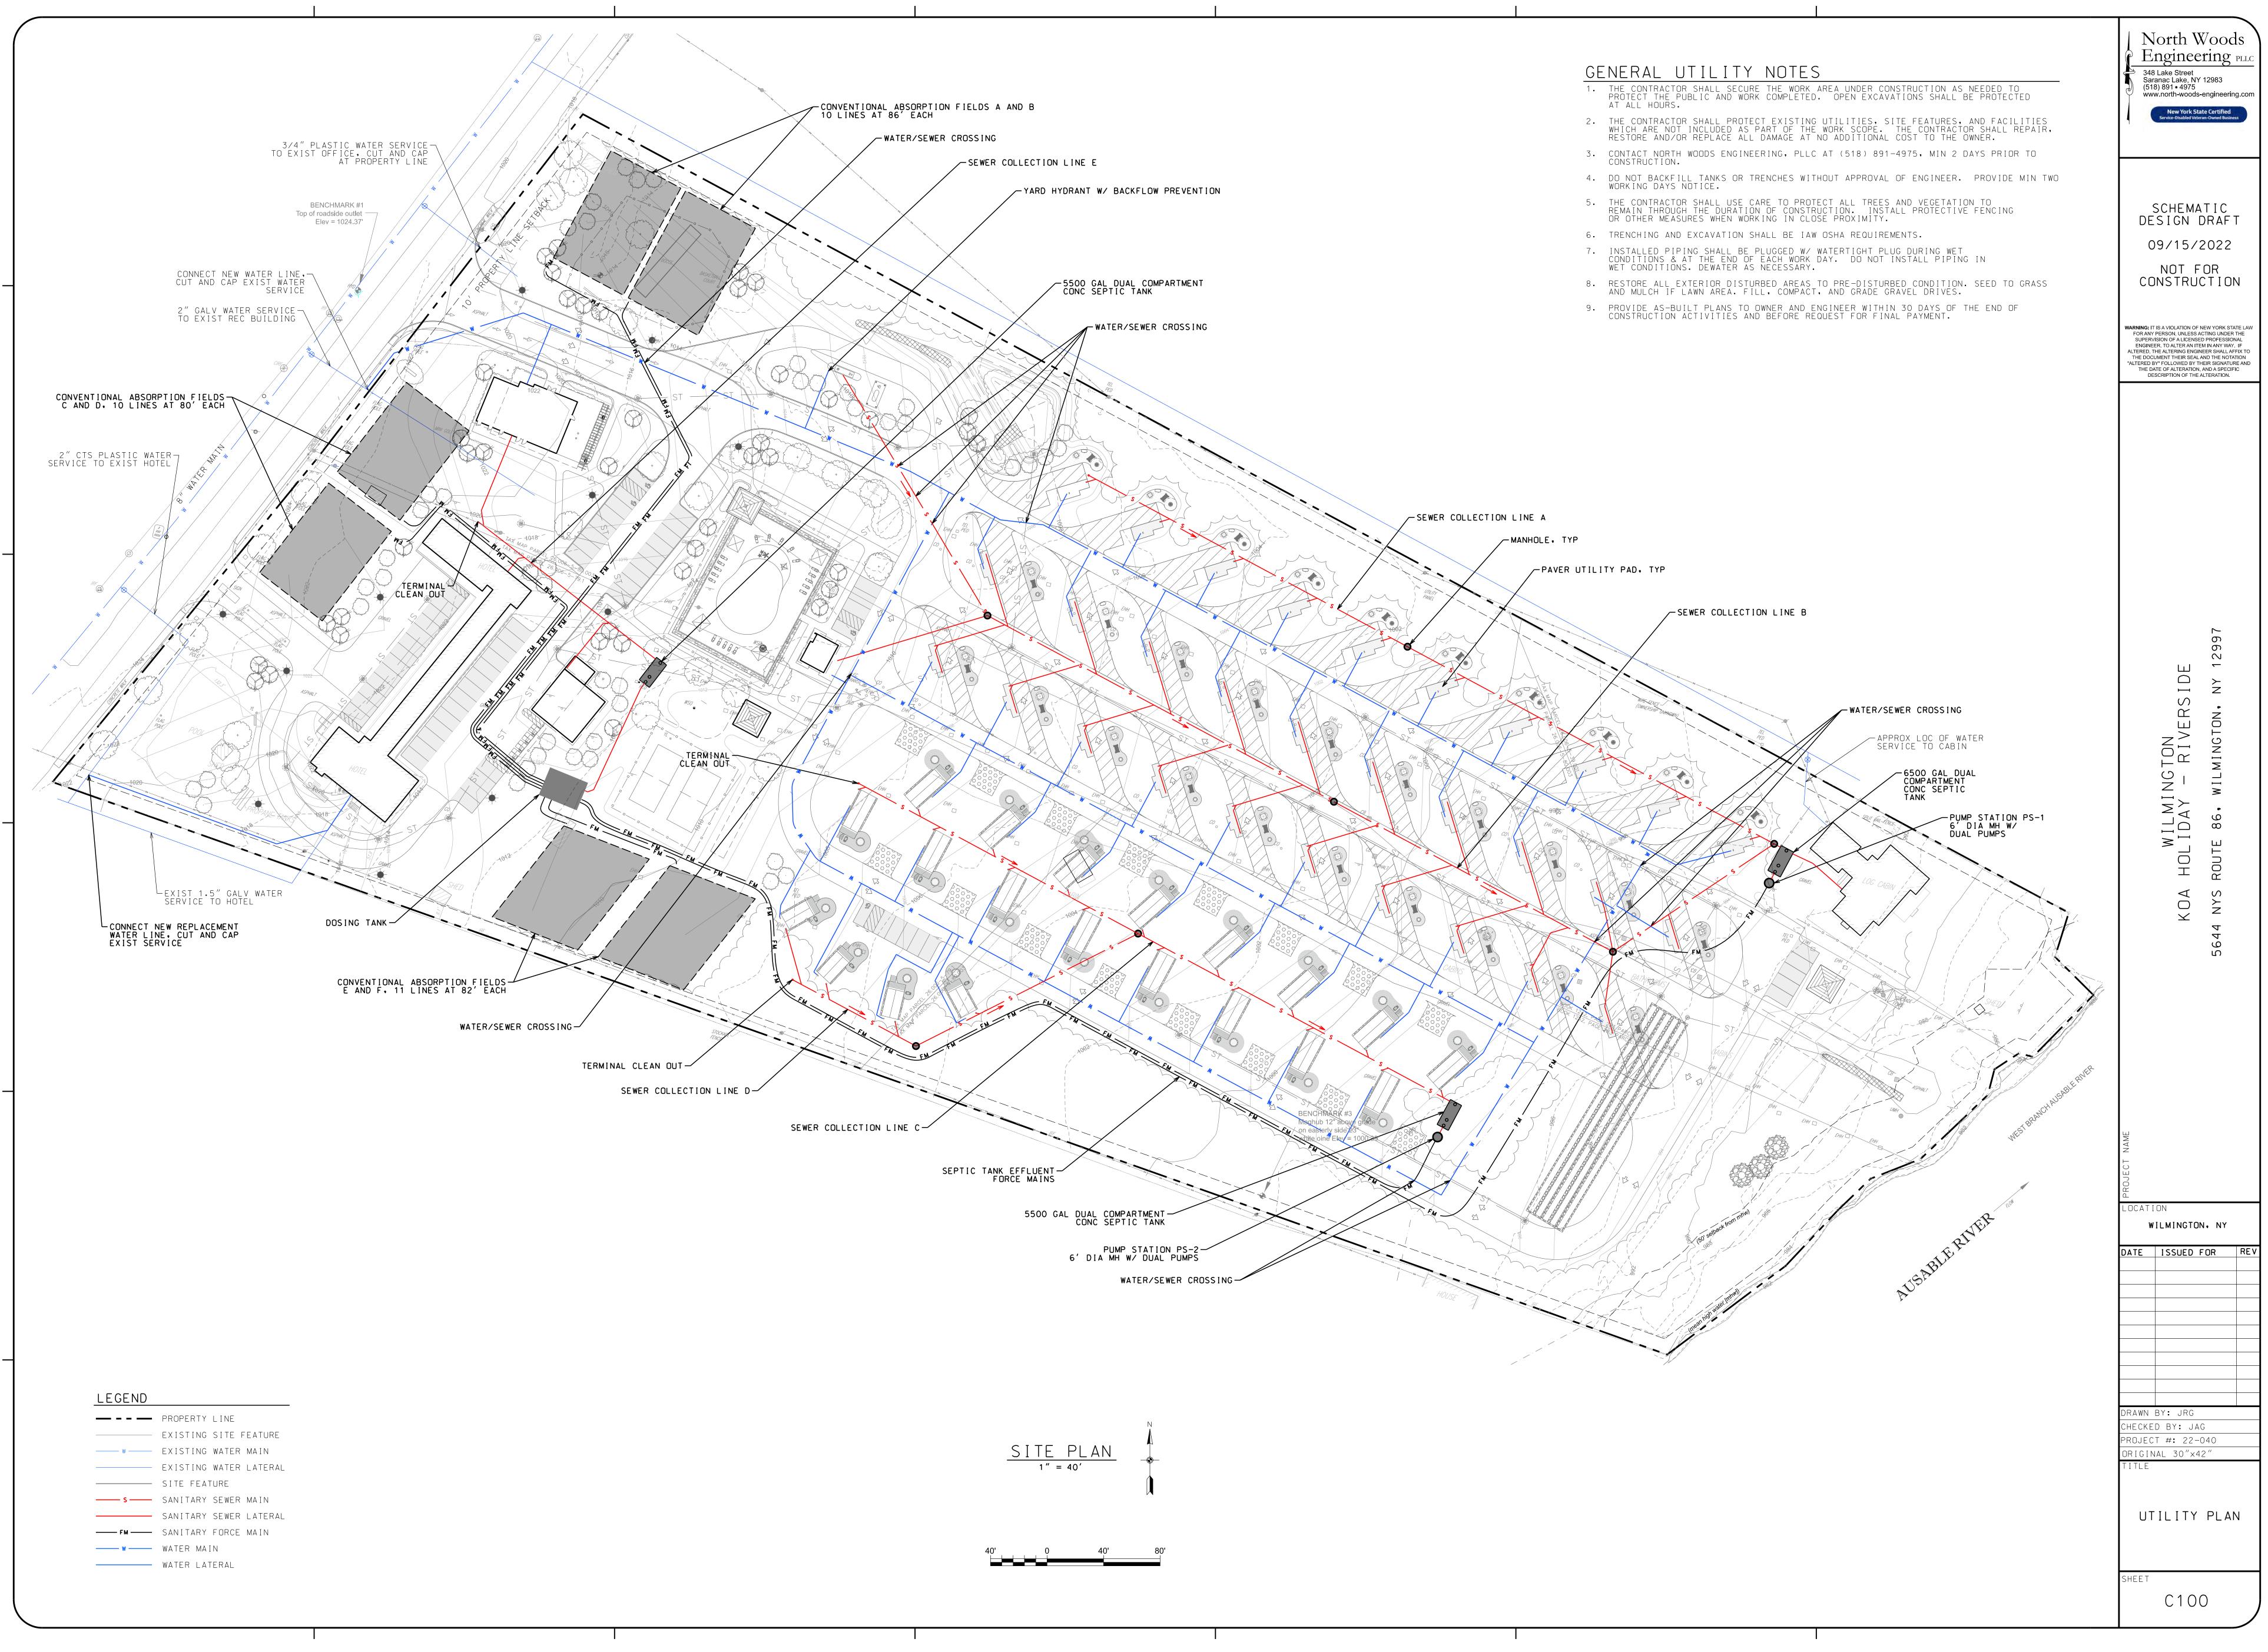

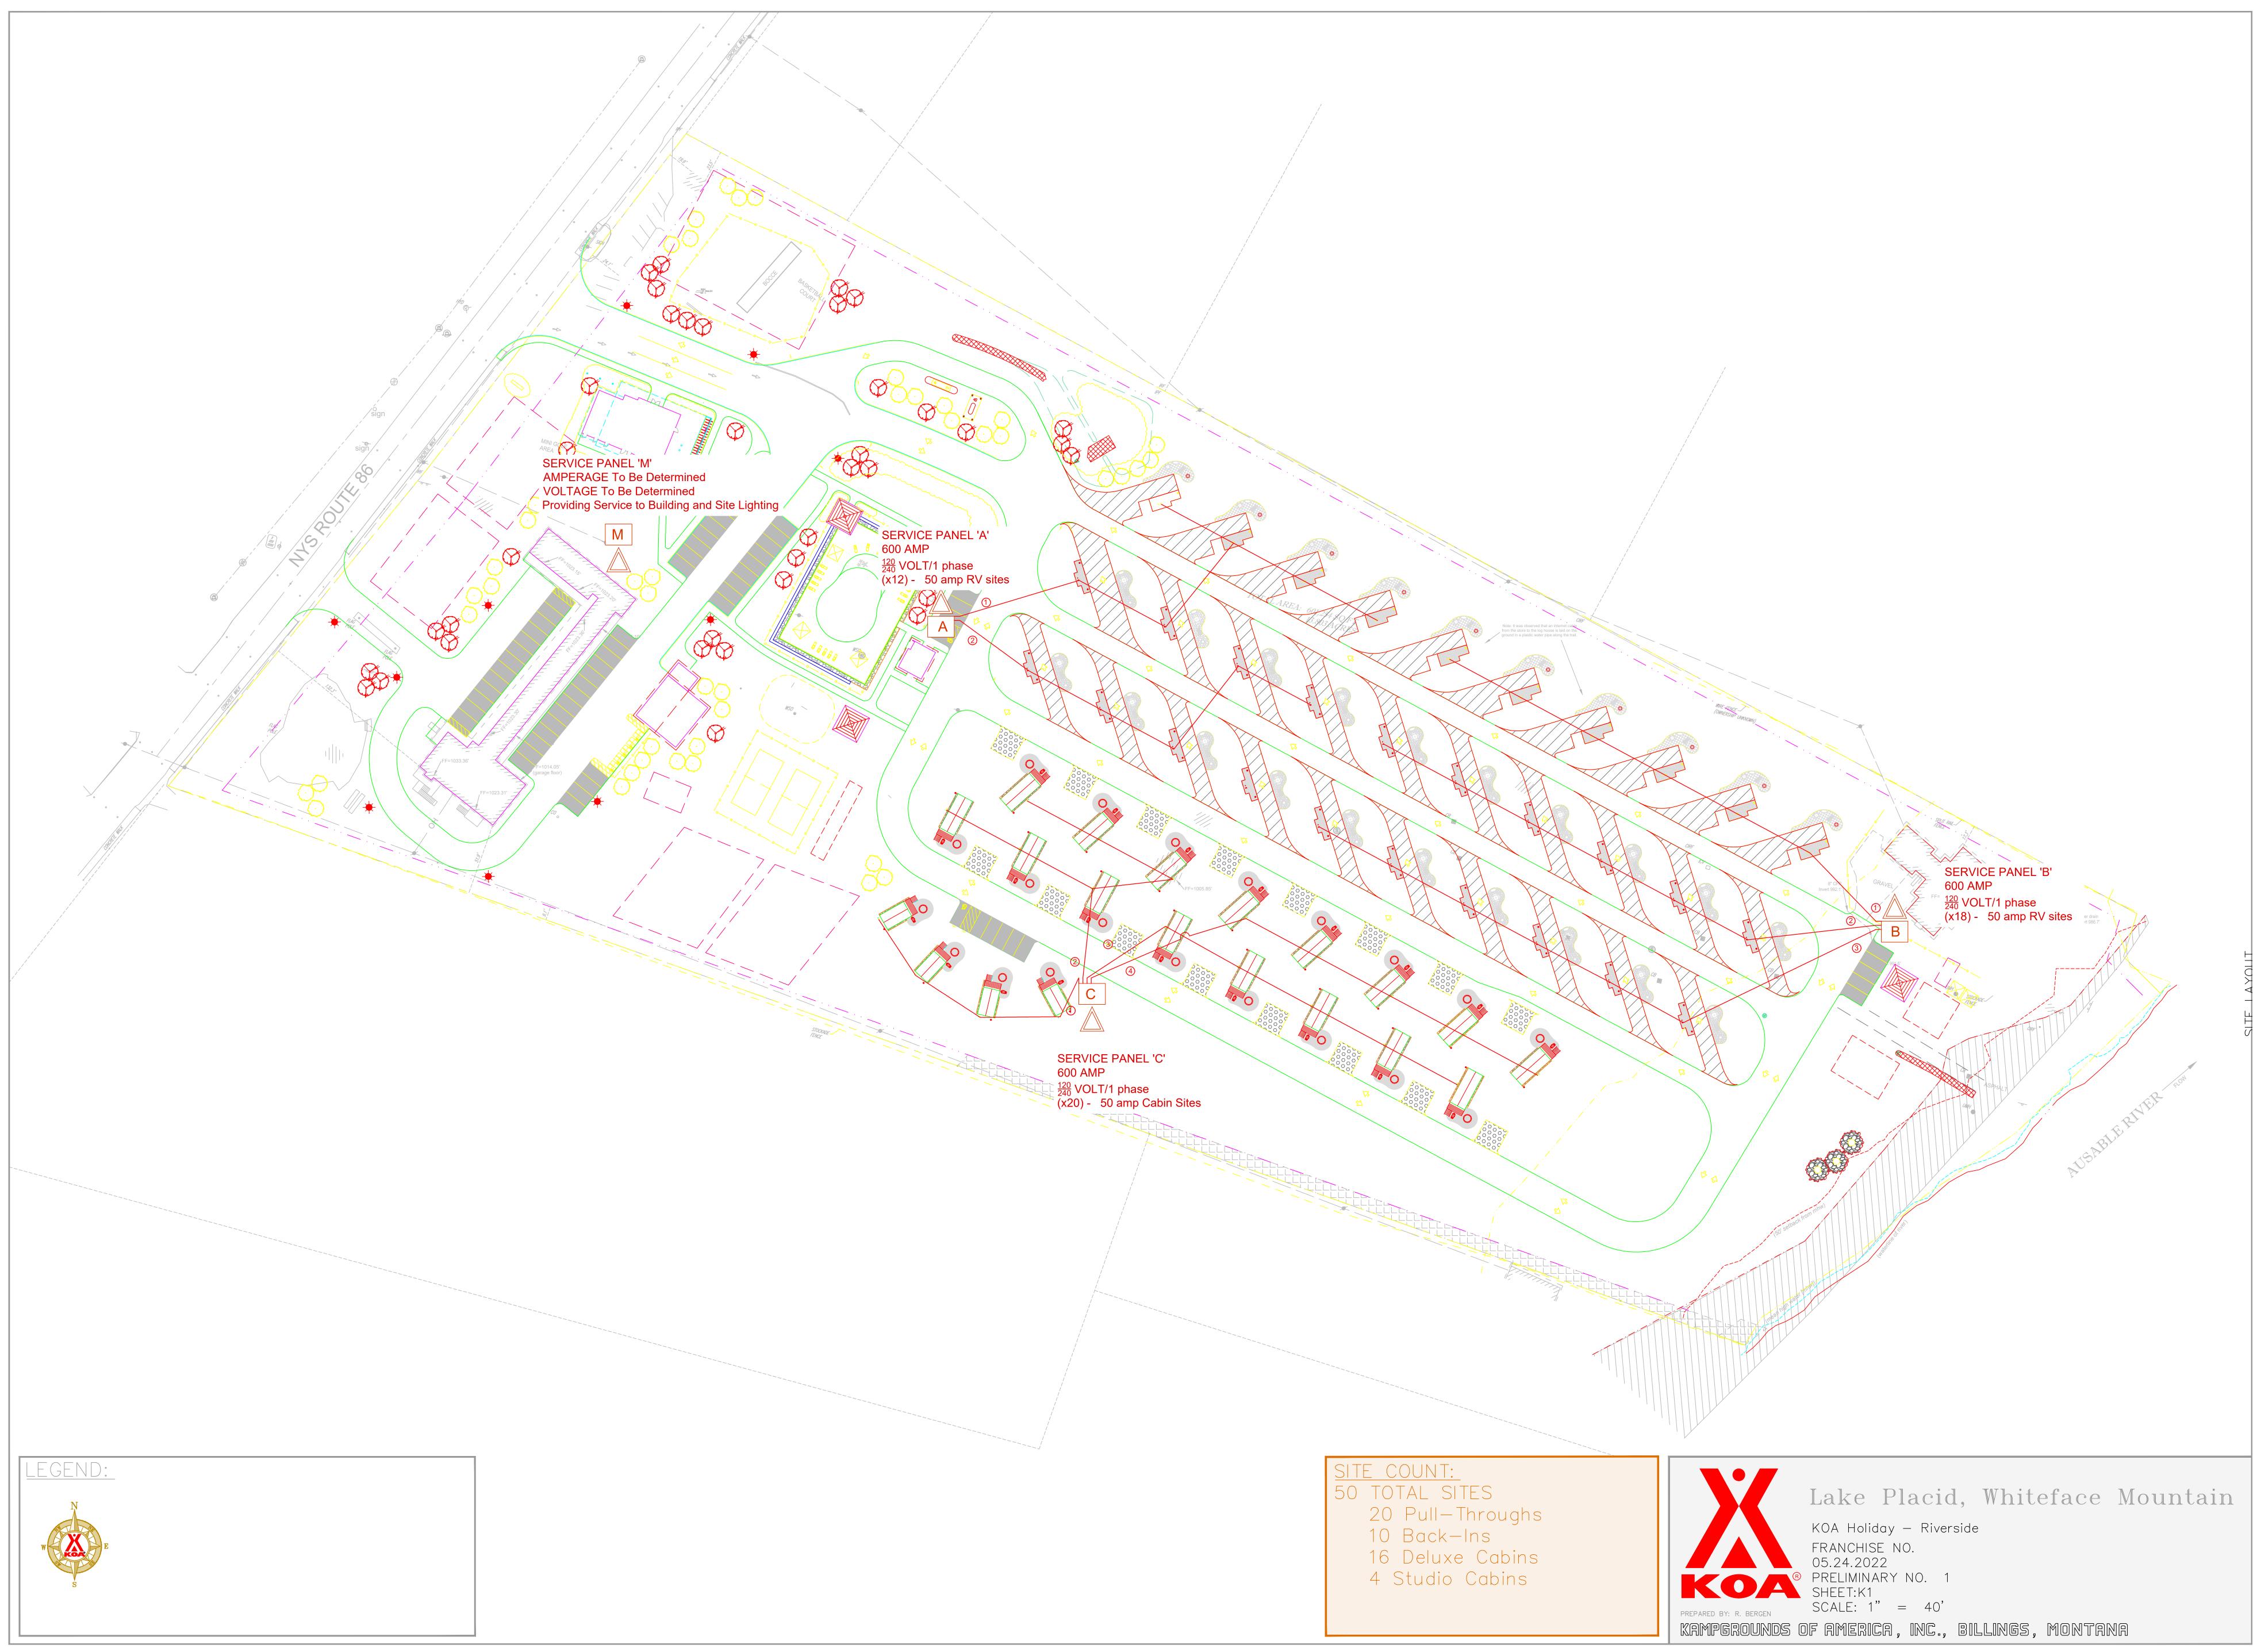

September 10, 2021


KAMPGROUNDS OF AMERICA **CHECK-IN BUILDING - MID SIZE**

SHEET INDEX

CVR COVER A101 SITE PLAN A101 FLOOR PLAN A201 ELEVATIONS A301 SECTIONS & ROOF PLAN A401 LIGHTING PLAN

PROJECT DESCRIPTION

This project consist of a check-in area, camp store, coffee and snack area, restrooms, shower rooms, laundry rooms, office, and storage area.

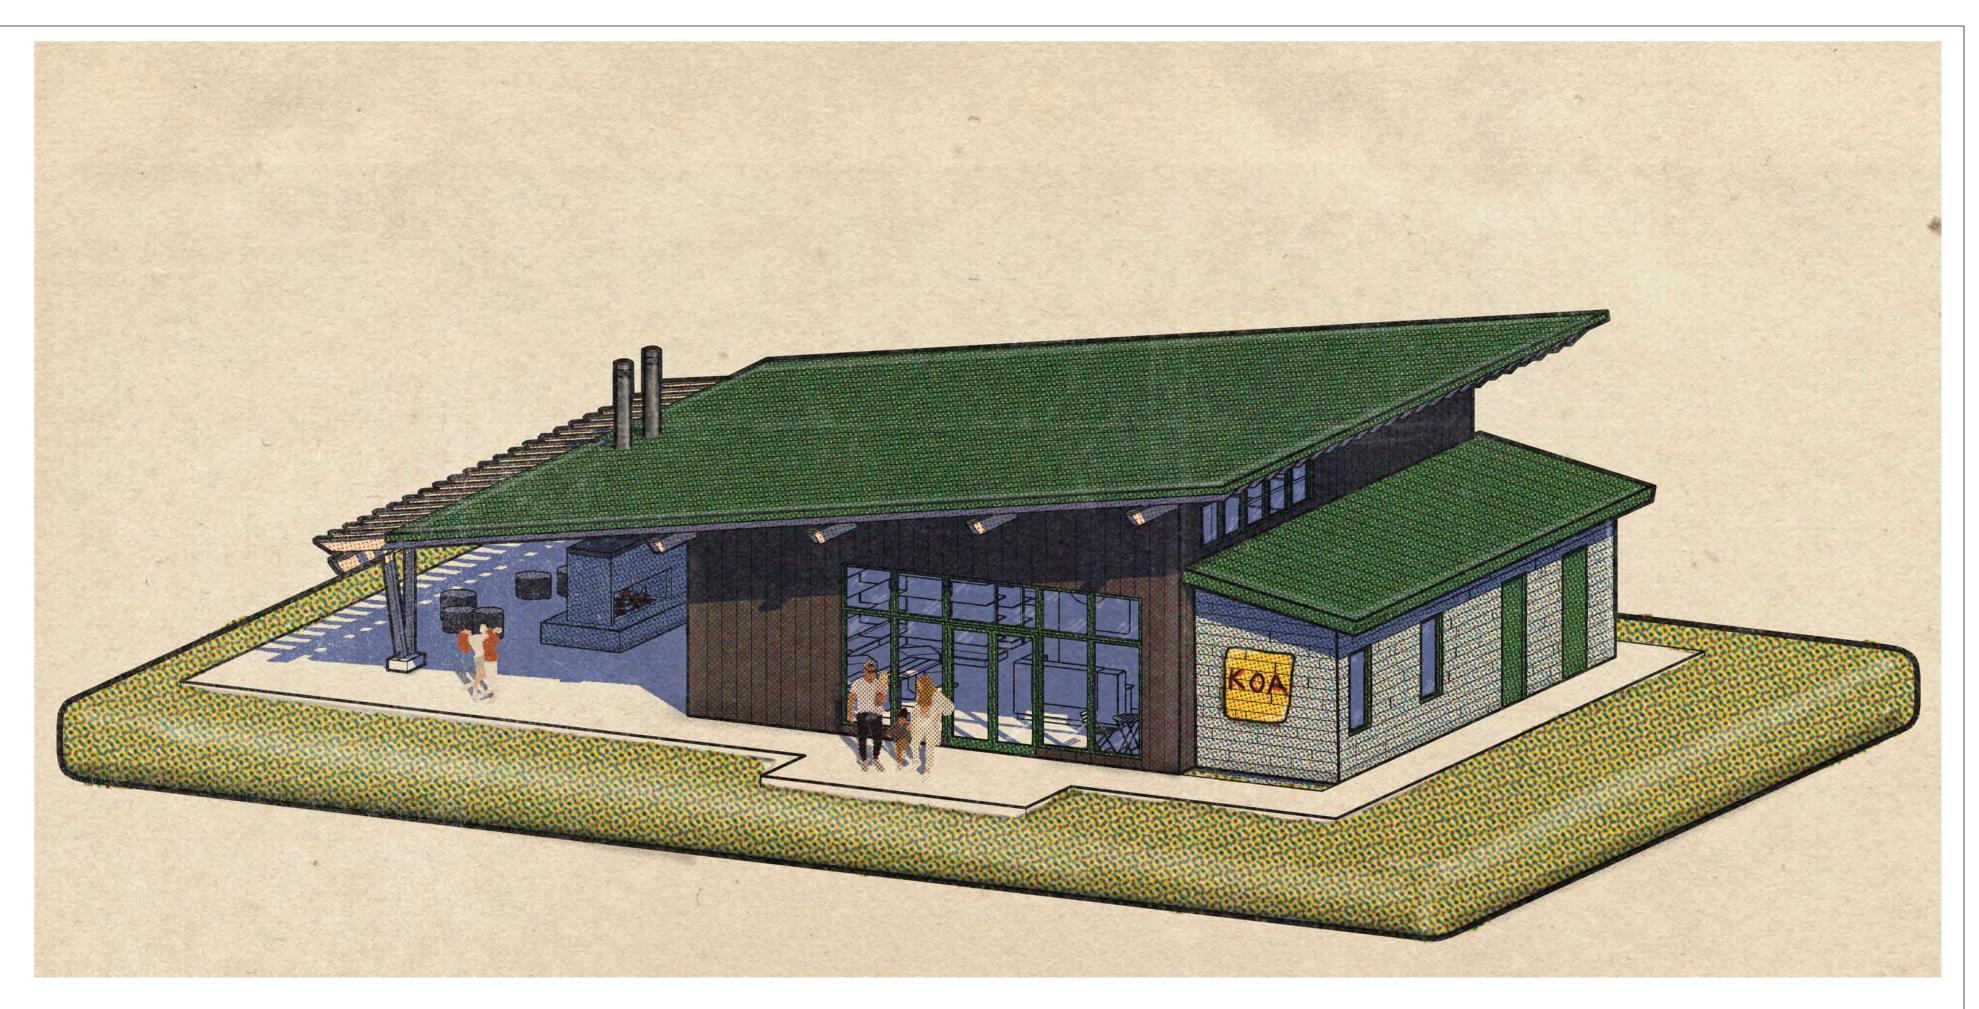

FOR VISUALIZATION PURPOSES ONLY



ILDING/STORE Ω Ζ KAMPGROUNDS CHECK-PROTOTYPE

S


© 2021 I ALL RIGHTS RESERVED

NOT FOR CONSTRUCTION


DRAWN BY - Hendricks CHECKED BY -DATE 09.10.21

COVER

CVR KOA Documents - Mid Size, September 10, 2021

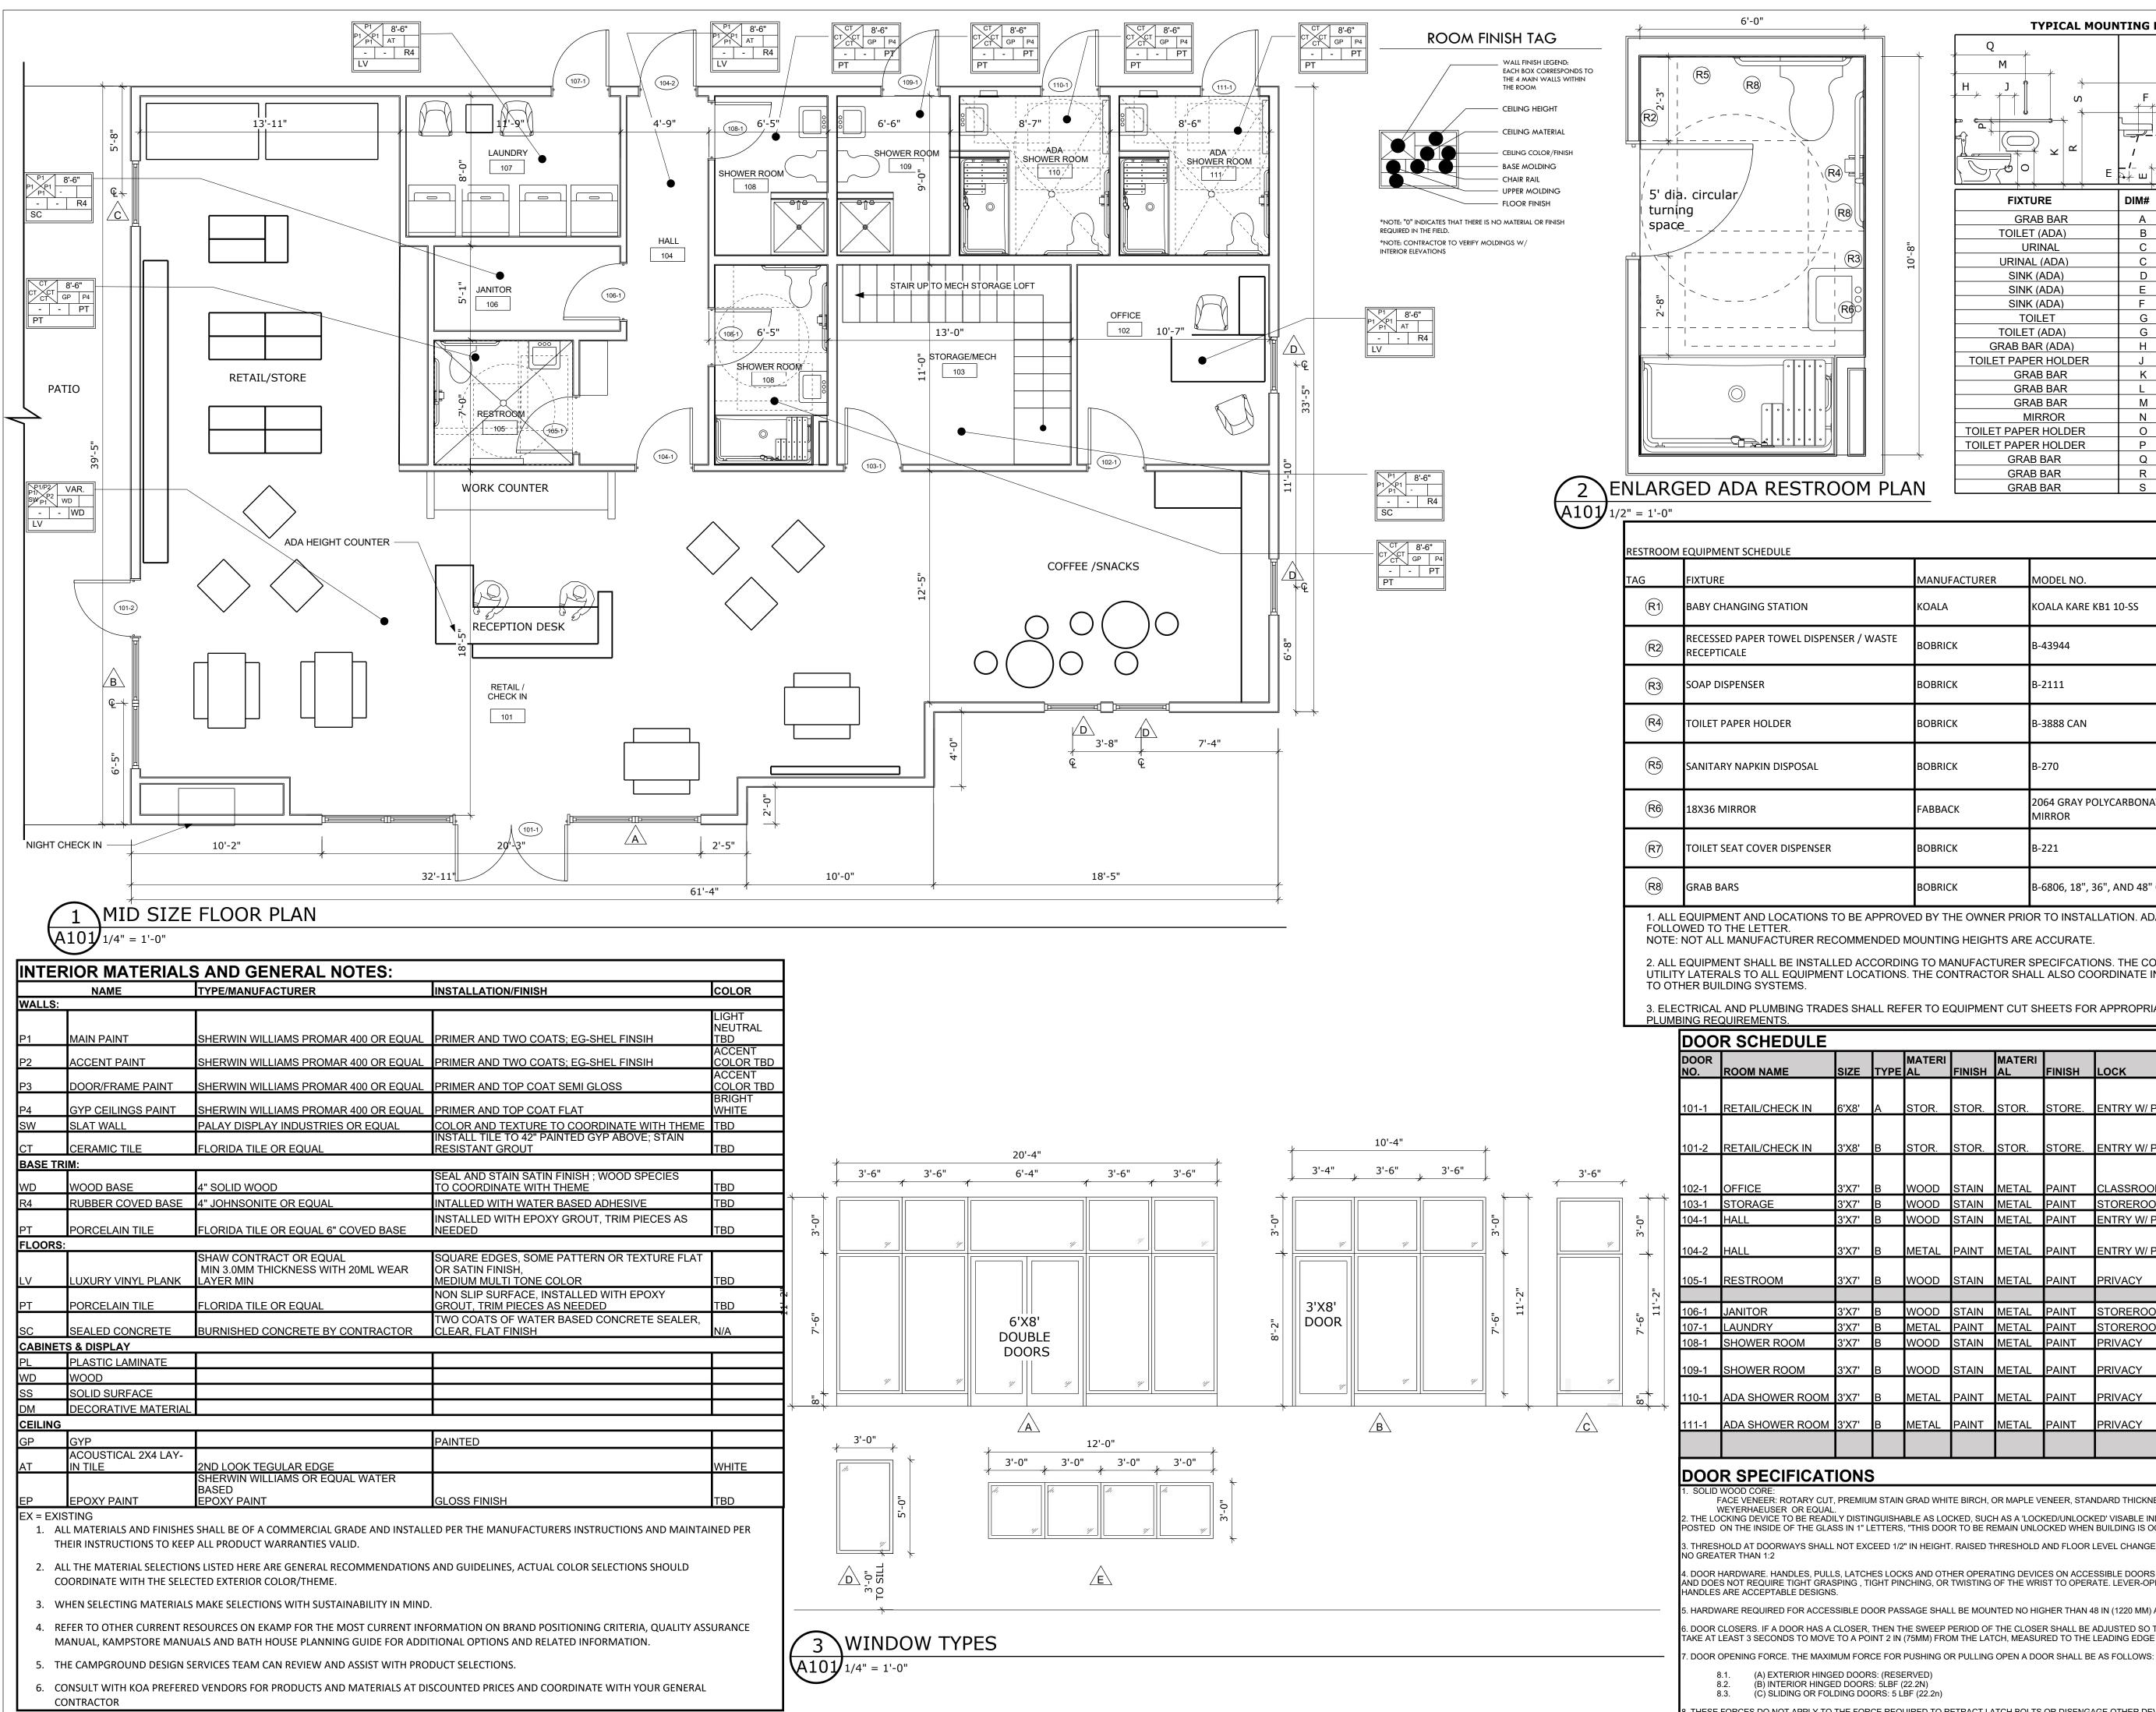

(C) SLIDING OR FOLDING DOORS: 5 LBF (22.2n) THESE FORCES DO NOT APPLY TO THE FORCE REQUIRED TO RETRACT LATCH BOLTS OR DISENGAGE OTHER DEVICES THAT HOLDS THE DOOR IN A CLOSED POSITION.

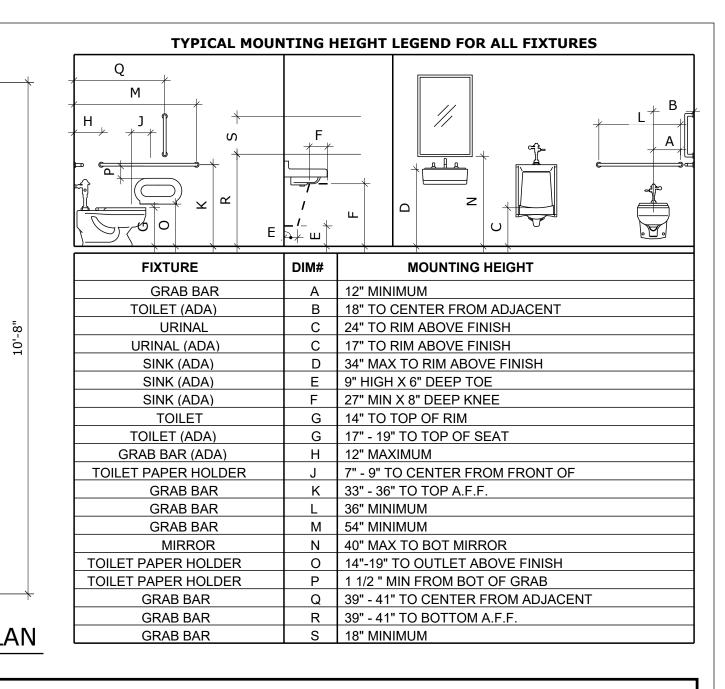

	MANUFACTURER	MODEL NO.	POWER	NOTES
	KOALA	KOALA KARE KB1 10-SS	NONE	
NSER / WASTE	BOBRICK	B-43944	NONE	SATIN FINISH STAINLESS STEEL
	BOBRICK	B-2111	NONE	SATIN FINISH STAINLESS STEEL
	BOBRICK	B-3888 CAN	NONE	SATIN FINISH STAINLESS STEEL
	BOBRICK	B-270	NONE	SATIN FINISH STAINLESS STEEL
	FABBACK	2064 GRAY POLYCARBONATE MIRROR	NONE	ARMADILLO SCRATCH COATING MOUNT IN ALUM. J-MTL FRAME
	BOBRICK	B-221	NONE	SATIN FINISH STAINLESS STEEL
	BOBRICK	B-6806, 18", 36", AND 48" OR EQ		

1. ALL EQUIPMENT AND LOCATIONS TO BE APPROVED BY THE OWNER PRIOR TO INSTALLATION. ADA & ICC A117.1 - 2009 REQUIREMENTS MUST BE NOTE: NOT ALL MANUFACTURER RECOMMENDED MOUNTING HEIGHTS ARE ACCURATE.

2. ALL EQUIPMENT SHALL BE INSTALLED ACCORDING TO MANUFACTURER SPECIFCATIONS. THE CONTRACTOR SHALL BE RESPONSIBLE FOR PROVIDING UTILITY LATERALS TO ALL EQUIPMENT LOCATIONS. THE CONTRACTOR SHALL ALSO COORDINATE INSTALLATION WITH OTHER TRADES TO AVOID DAMAGE

3. ELECTRICAL AND PLUMBING TRADES SHALL REFER TO EQUIPMENT CUT SHEETS FOR APPROPRIATE PLACEMENT FOR BOTH POWER SUPPLY AND

	0175	TVDE	MATERI		MATERI		LOCK	CLO	STOD	HARDWARE
	SIZE	TYPE	AL	FINISH	AL	FINISH	LOCK	SER	STOP	FINISH
	6'X8'	А	STOR.	STOR.	STOR.	STORE.	ENTRY W/ PANIC HARDWARE	YES	CLOSER	US26D
		D			OTOD	OTODE				
_	3'X8'	В	STOR.	STOR.	STOR.	STORE.	ENTRY W/ PANIC HARDWARE	YES	CLUSER	US26D
	3'X7'	В	WOOD	STAIN	METAL	PAINT	CLASSROOM	NO	WALL	US26D
	3'X7'	В	WOOD	STAIN	METAL	PAINT	STOREROOM	YES	WALL	US26D
	3'X7'	В	WOOD	STAIN	METAL	PAINT	ENTRY W/ PANIC HARDWARE	YES	WALL	US26D
	3'X7'	В	METAL	PAINT	METAL	PAINT	ENTRY W/ PANIC HARDWARE	YES	CLOSER	US26D
	3'X7'	В	WOOD	STAIN	METAL	PAINT	PRIVACY	YES	WALL	US26D
	3'X7'	В	WOOD	STAIN	METAL	PAINT	STOREROOM	YES	WALL	US26D
	3'X7'	В	METAL	PAINT	METAL	PAINT	STOREROOM	T	CLOSER	US26D
	3'X7'	В	WOOD	STAIN	METAL	PAINT	PRIVACY	YES	WALL	US26D
	3'X7'	В	WOOD	STAIN	METAL	PAINT	PRIVACY	YES	CLOSER	US26D
		D								
	3'X7'	В	METAL	PAINT	METAL	PAINT	PRIVACY	YES	CLOSER	US26D
	3'X7'	В	METAL	PAINT	METAL	PAINT	PRIVACY	YES	CLOSER	US26D
	• / 11	_							CLOCEN	

FACE VENEER: ROTARY CUT, PREMIUM STAIN GRAD WHITE BIRCH, OR MAPLE VENEER, STANDARD THICKNESS THOROUGHLY KILN DRIED, MANUFACTURED BY THE LOCKING DEVICE TO BE READILY DISTINGUISHABLE AS LOCKED, SUCH AS A 'LOCKED/UNLOCKED' VISABLE INDICATOR/ ALSO, A READILY VISABLE DURABLE SIGN SHALL BE OSTED ON THE INSIDE OF THE GLASS IN 1" LETTERS, "THIS DOOR TO BE REMAIN UNLOCKED WHEN BUILDING IS OCCUPIED".

THRESHOLD AT DOORWAYS SHALL NOT EXCEED 1/2" IN HEIGHT. RAISED THRESHOLD AND FLOOR LEVEL CHANGES AT ACCESSIBLE DOORWAYS SHALL BE BEVELED WITH A SLOPE

4. DOOR HARDWARE. HANDLES, PULLS, LATCHES LOCKS AND OTHER OPERATING DEVICES ON ACCESSIBLE DOORS SHALL HAVE A SHAPE THAT IS EASY TO GRASP WITH ONE HAND AND DOES NOT REQUIRE TIGHT GRASPING , TIGHT PINCHING, OR TWISTING OF THE WRIST TO OPERATE. LEVER-OPERATED MECHANISMS, PUSH-TYPE MECHANISMS, AND U-SHAPED

. HARDWARE REQUIRED FOR ACCESSIBLE DOOR PASSAGE SHALL BE MOUNTED NO HIGHER THAN 48 IN (1220 MM) ABOVE FINSHED FLOOR.

DOOR CLOSERS. IF A DOOR HAS A CLOSER, THEN THE SWEEP PERIOD OF THE CLOSER SHALL BE ADJUSTED SO THAT FROM AN OPEN POSITION OF 90 DEGREES, THE DOOR WILL AKE AT LEAST 3 SECONDS TO MOVE TO A POINT 2 IN (75MM) FROM THE LATCH, MEASURED TO THE LEADING EDGE OF THE DOOR.

(A) EXTERIOR HINGED DOORS: (RESERVED)



Ш 0 $\mathbf{\Omega}$ S ğ **Y** PROTOT Ŭ


© 2021 I ALL RIGHTS RESERVED

NOT FOR CONSTRUCTION


DRAWN BY - Hendricks CHECKED BY -DATE 09.10.21

MID SIZE PLAN



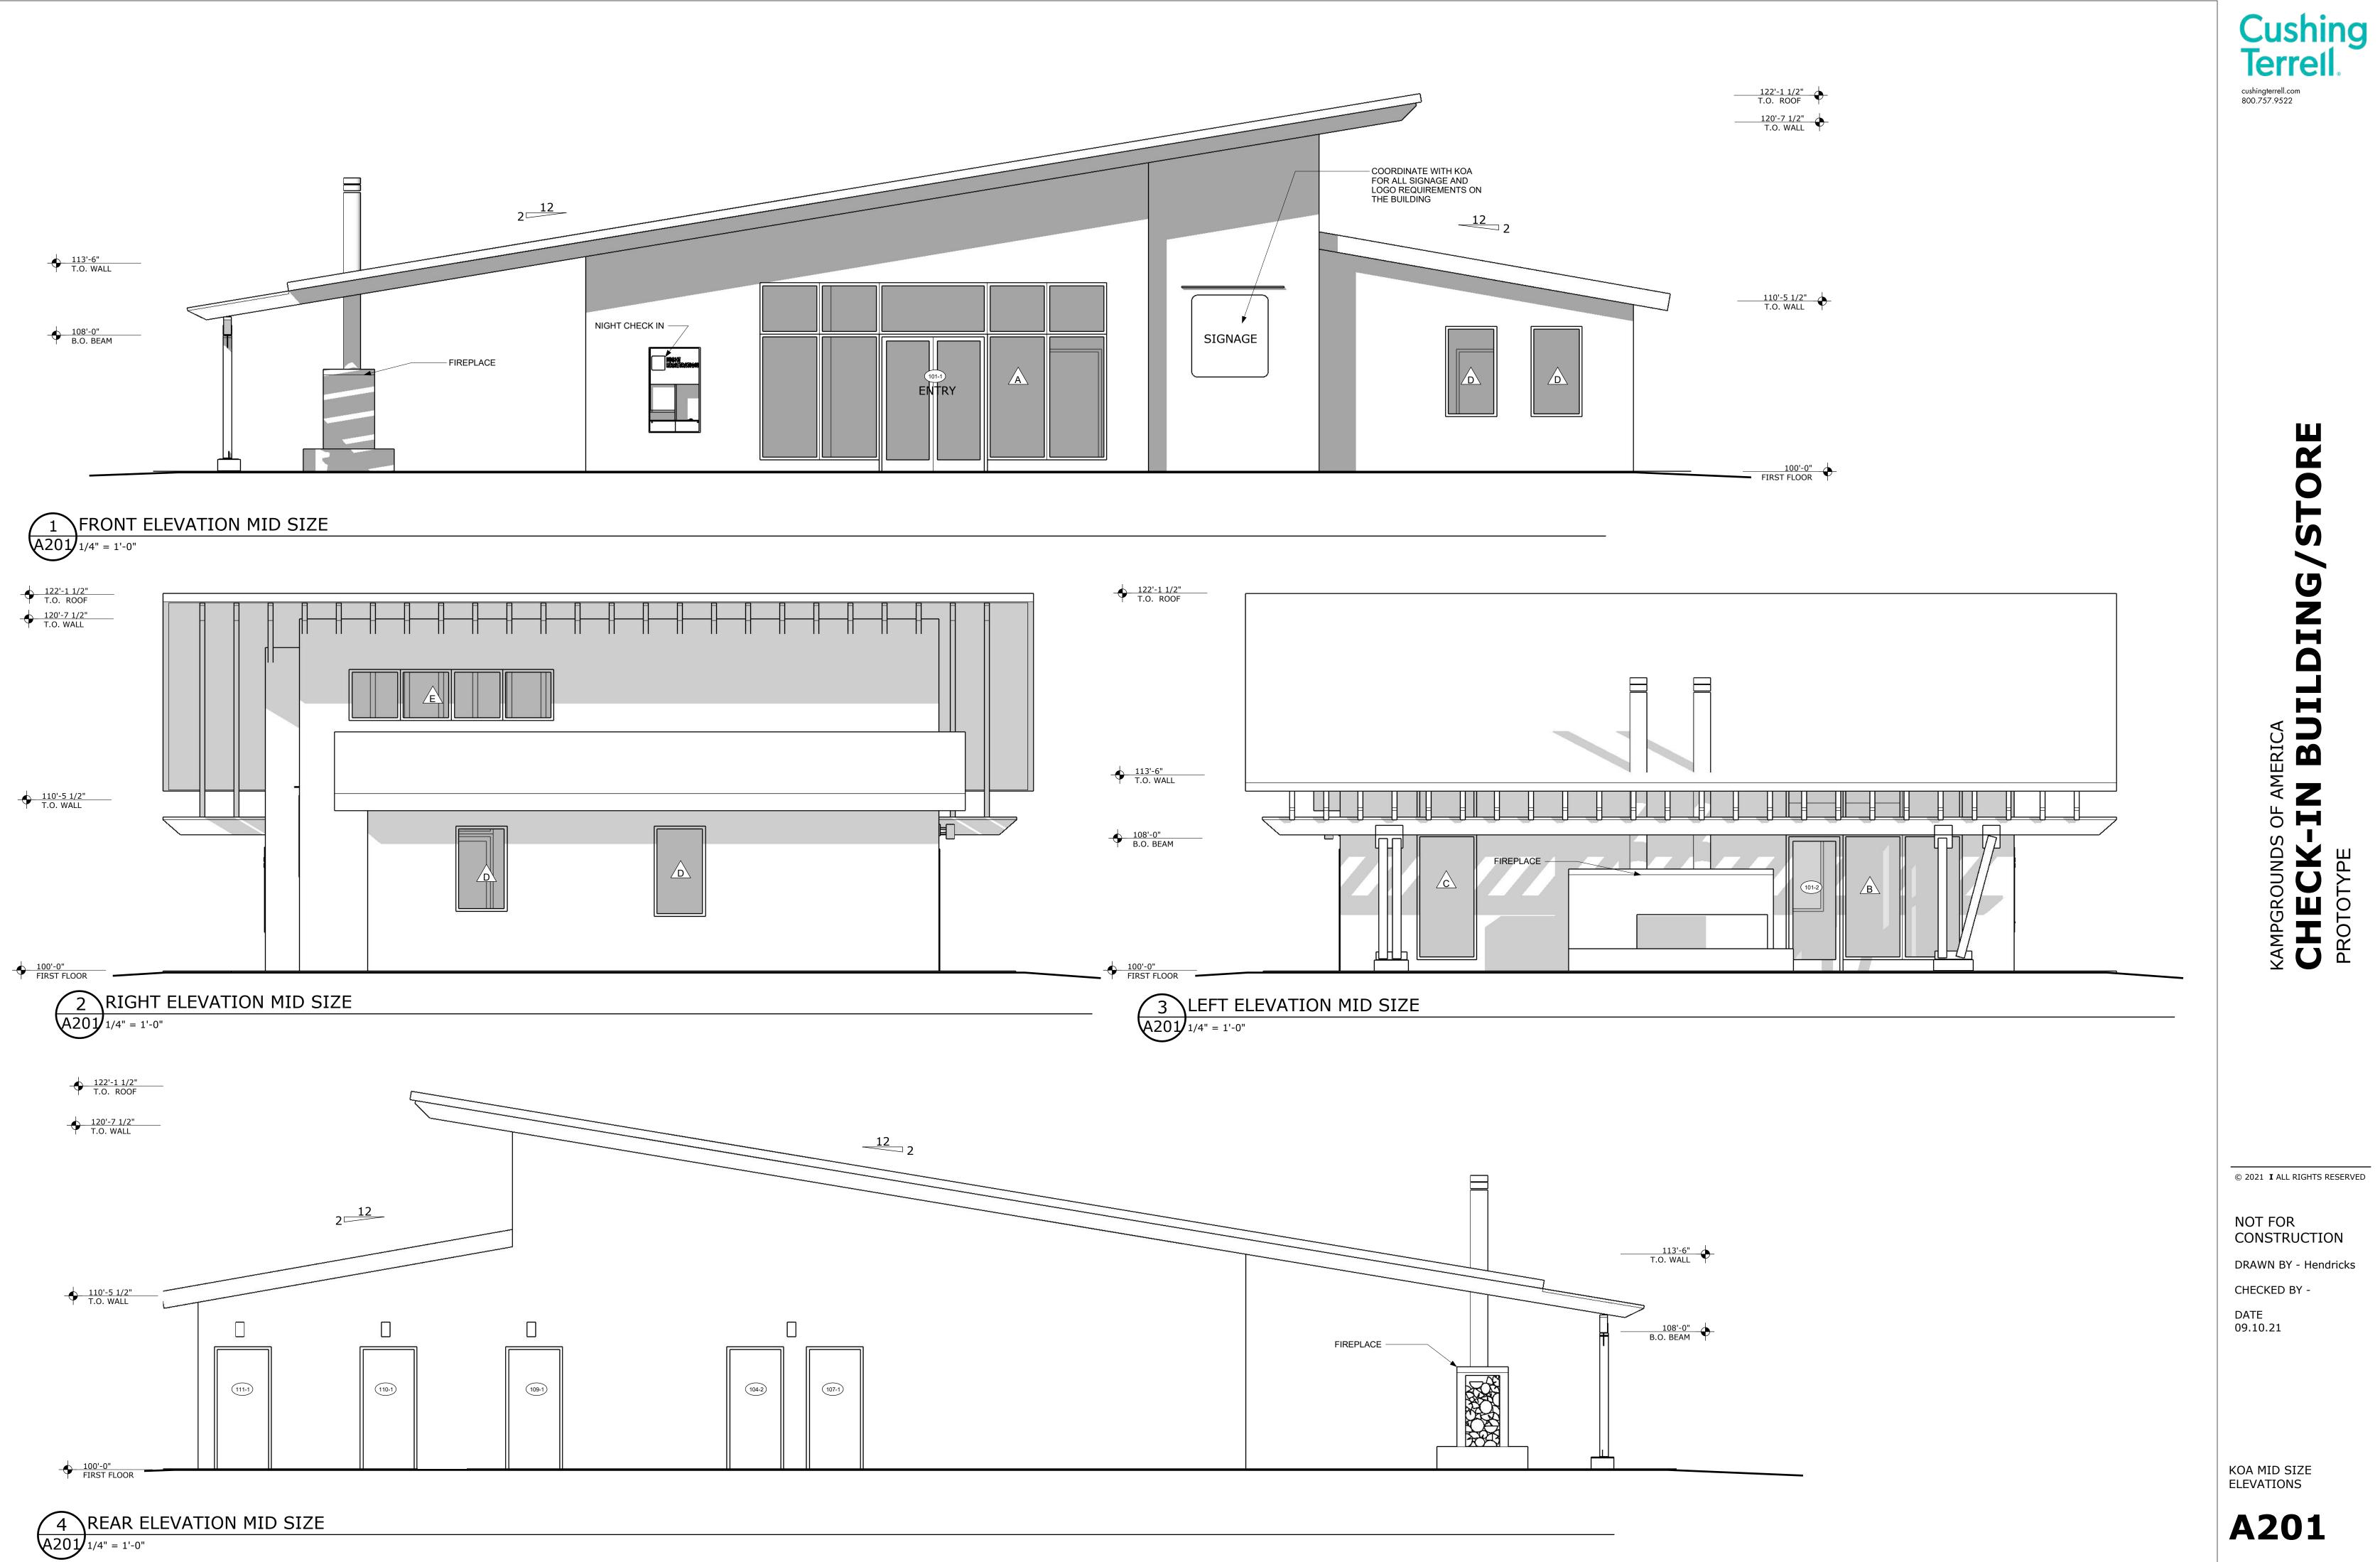

KOA Documents - Mid Size, September 10, 2021

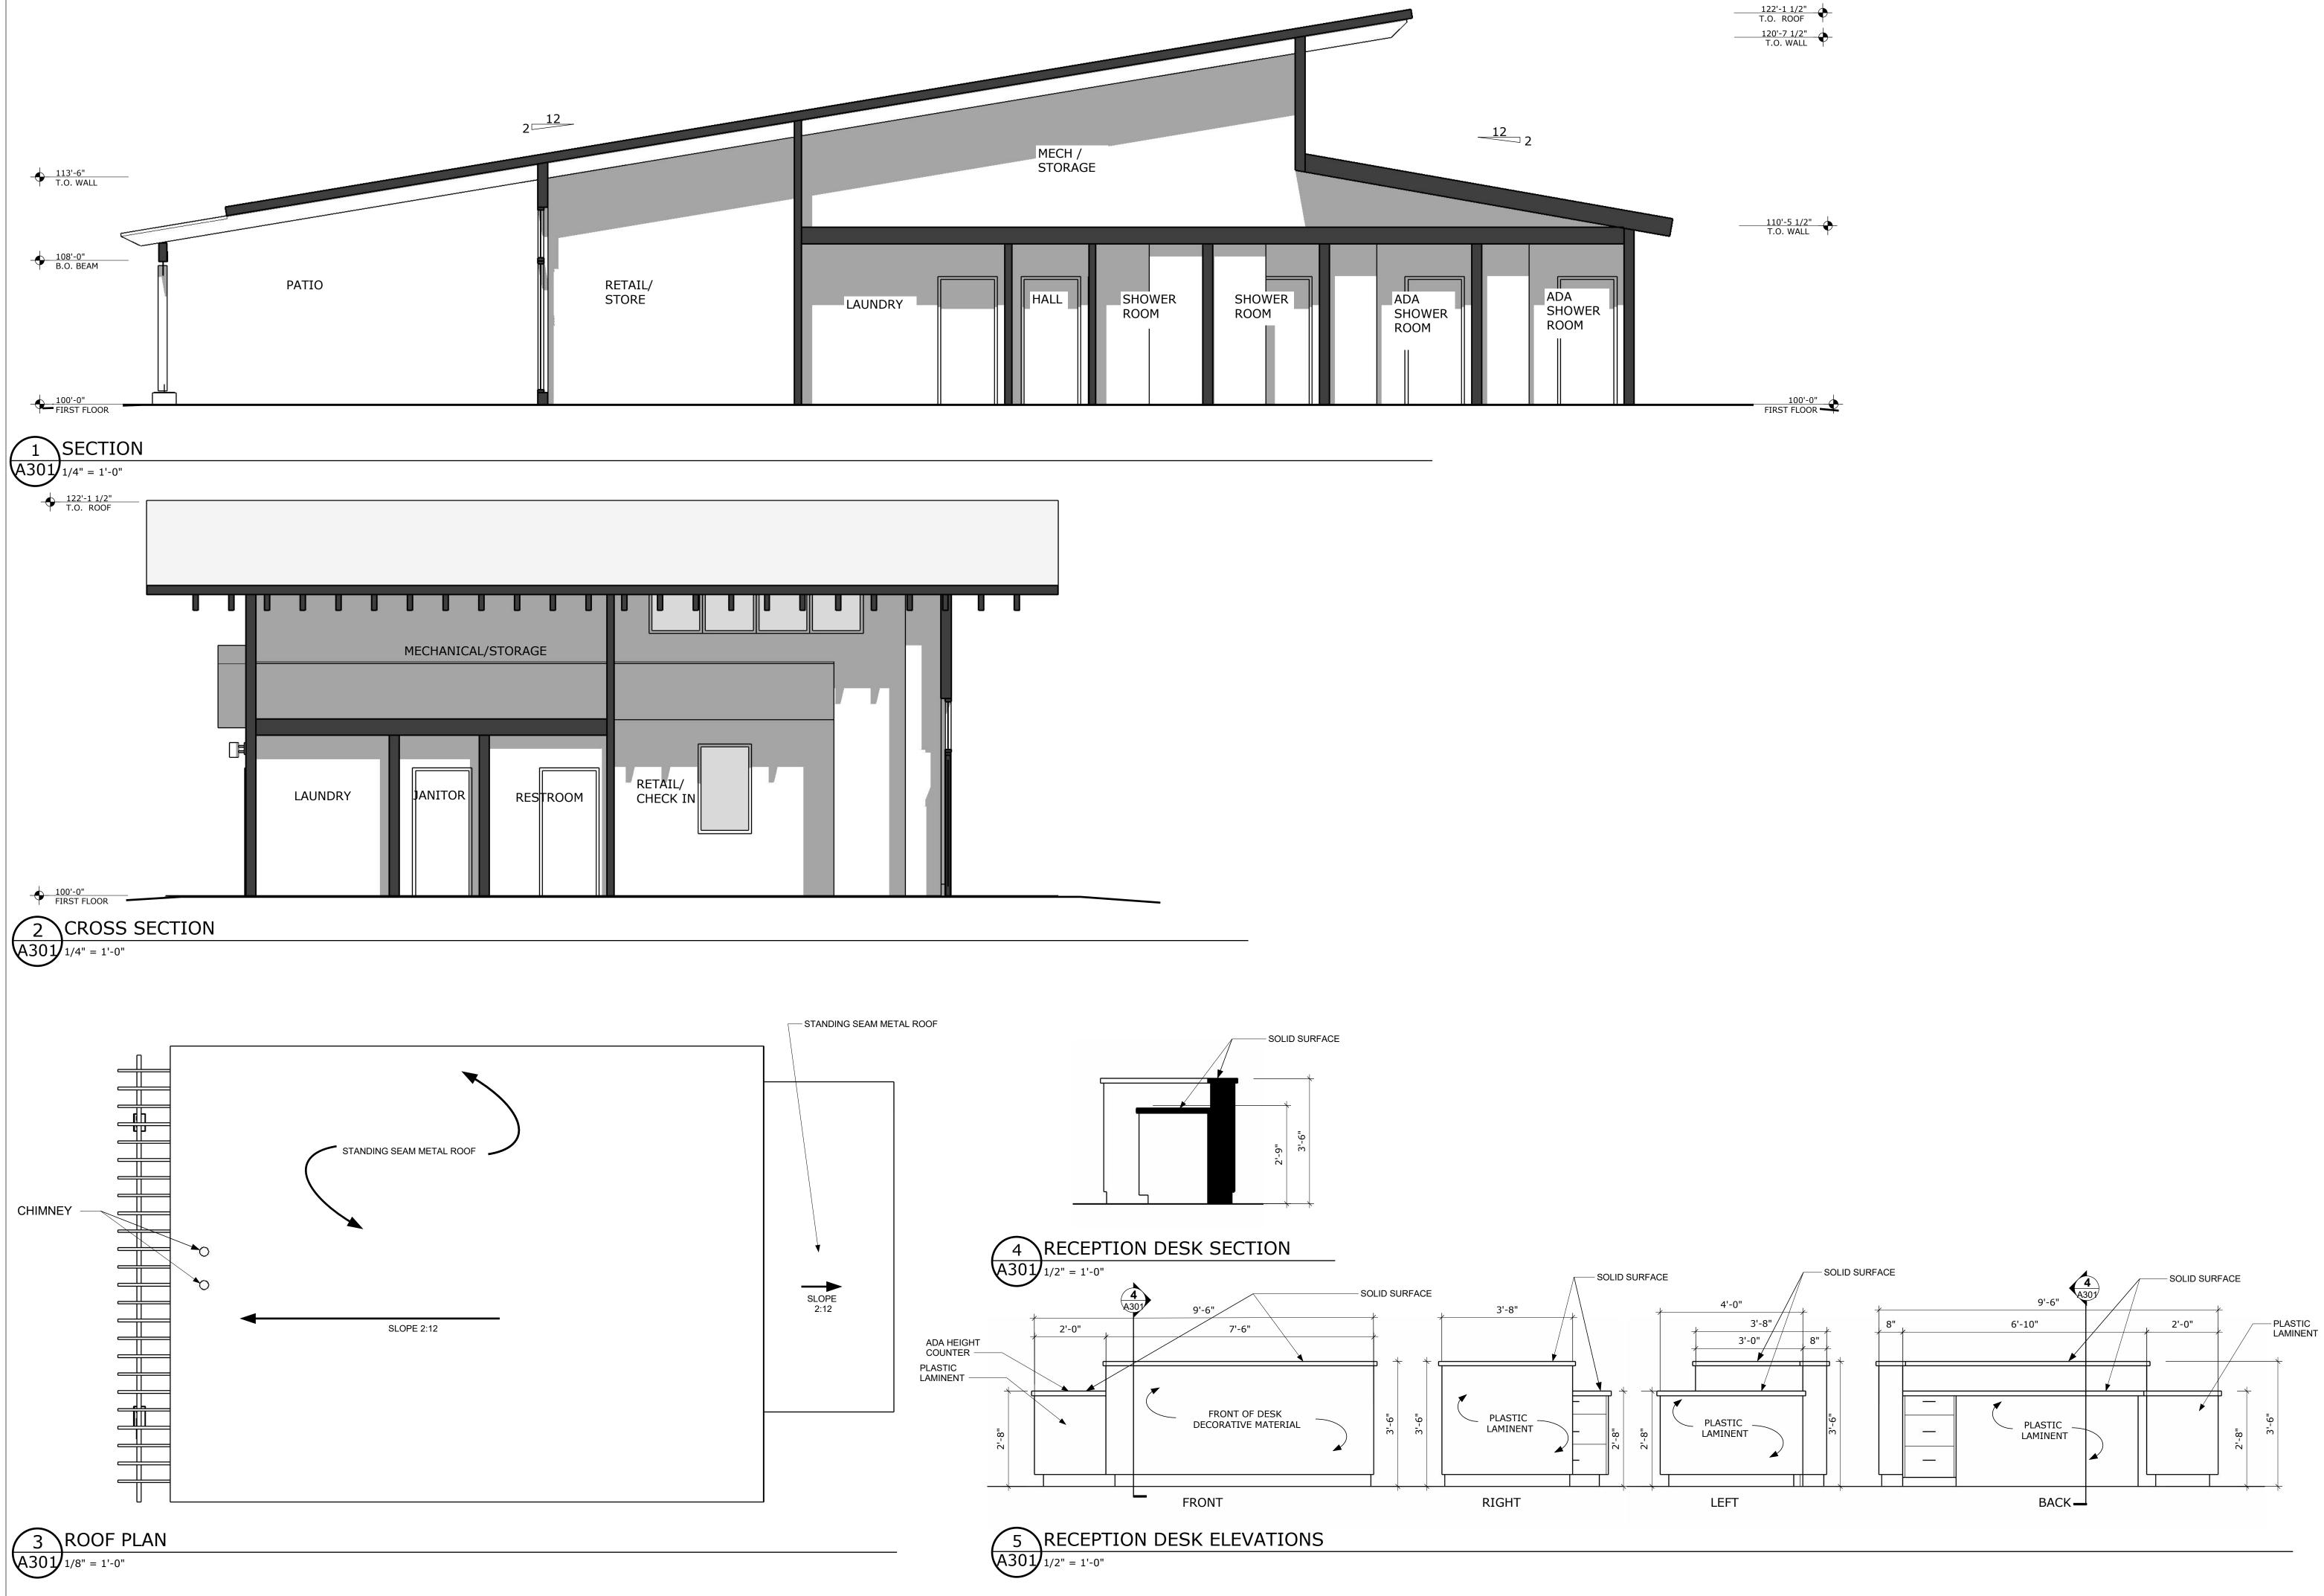





STORE DING Z ∢ CHECK-PROTOTYPE

© 2021 I ALL RIGHTS RESERVED

NOT FOR CONSTRUCTION

DRAWN BY - Hendricks CHECKED BY -DATE 09.10.21

KOA MID SIZE SECTIONS AND ROOF PLAN



KOA Documents - Mid Size, September 10, 2021

LIGHTING PLAN LEGEND

Image: height stateWall sconceImage: height stateSURFACE MOUNTED CEILING
LIGHTImage: height stateRECESSED CEILING LIGHTImage: height stateSUSPENDED LINEAR CEILING
LIGHTImage: height stateSURFACE MOUNT LINEAR LIGHTImage: height stateSURFACE MOUNT LIGHTImage: height stateSurface Mount Light

Heating, Ventilating, and Air Conditioning (HVAC) Narrative:

HVAC load calculations shall be performed based on building size, latest ASHRAE weather conditions for region nearest the campground, and minimum building envelope requirements from the latest International Energy Conservation Code (IECC).

In mild climates where freezing conditions do not exist, air cooled heat pump system(s) should be used. In more extreme climates where freezing conditions do exist, a gas fired heating furnace(s) with split air cooled DX air conditioning should be used. Ventilation and/or make-up air for these systems shall be provided with a heat recovery ventilator (HRV). Exhaust air from laundry room and all toilet/shower rooms shall run through the HRV to temper an equal volume of fresh outside air. Outside air from the HRV shall be ducted into the return air side or each heat pump or furnace system. A transfer air path from main portion of the building to Laundry Room and all Toilet/Shower Rooms shall be provided.

Stair access to conditioned attic space above back portion of building will be provided. All mechanical equipment/fans shall be located in the attic space.

Heat pump(s) and/or furnaces shall be ducted throughout the building. Rectangular ducts shall be used in concealed spaces where not visible. Large open/vaulted areas where ductwork is visible, round spiral supply ducts shall be used with duct mounted diffusers. Low return grilles shall be placed near the floor in all open/vaulted areas.

ELECTRICAL NARRATIVE

General Description:

The scope is to provide design and engineering of the new electrical systems for the entire project. The electrical systems mentioned below will be designed to in compliance with the current codes and standards.

Systems Description:

Power Distribution System:

- A new 120/240-volt, 1-phase, 3-wire, or 120/280 3phase 4 wire service fed from a new pad-mounted, transformer will supply the building. It is anticipated that a direct metered, 320A meter base feeding a 400A panelboard will be used. The new 400A Main Distribution Panelboard (MDP) will have a surge protective device installed.
- All new wiring devices (receptacles and switches) will be specification grade. Light switches will be rated at 20 amps and commercial dryers at 30 amps. All cover plates will be high abuse. Receptacles will be spaced and circuited per the National Electric Code (NEC) requirements. All general-purpose receptacles will be 120-volt single phase.
- GFCI receptacles will be installed outdoors, in bathrooms, adjacent to sinks, and any other areas required by the NEC.
- All new home run circuit wiring will be in conduit, EMT minimum standard. Conductors will be copper only THHN/THWN. New branch circuits and feeders will include a wired equipment-grounding conductor. MC cable will be considered when allowed.

Interior Lighting Systems:

- All interior general lighting will have an LED source. LED fixture types will be selected based on LED life span to prevent relamping maintenance, efficacy to reduce power consumption, and light characteristics such as color temperature, color rendering index, and distribution to provide the best lighting solution possible.
- Decorative lighting will be provided in the lobby and other select areas.
- Exit signs will be LED type with battery back-up egress lighting provided at all exterior doors. Emergency lighting will be accounted for with battery ballasts in certain light fixtures.
- Lighting levels will be based on the Illuminating Engineering Society of North America (IESNA) guidelines and recommendations.
- Lighting controls will be designed around an intent for energy savings. Occupancy sensors will be used in halls, utility spaces, offices, and storage areas. Photocells will be used for control in any spaces with large daylight zones.

Exterior Lighting Systems:

- Exterior lighting will be a combination of wall mounted and canopy light fixtures to illuminate the entries, exterior signage, night check in and pathways in order to meet design intent and code requirements.
- Flagpole spotlights will be installed to illuminate flags.
- A photocell and time clock together will be used to control the exterior lighting.

Fire Alarm System:


A fully addressable fire alarm system is our recommendation to install to protect the building. There is usually a benefit from insurance companies when one is installed.


- A fully addressable fire alarm system will be installed; including smoke detectors, manual pull-stations, sprinkler flow and tamper monitor switches.
- The fire alarm system will be equipped with battery backup.
- A dialer will provide notification to a monitoring station.

Telecommunication Systems:

- A new underground telephone service entrance will feed a telecommunication/data board located in the electrical/mechanical space.
 A wall mounted rack with door and hinged patch panels and vertical wire manager will be located in the electrical/mechanical
- Infrastructure will include Category 6 cabling and data jacks. Two data jacks will be provided at each location that can be used for
- either voice or data. Wireless access points will be located throughout to provide adequate coverage.
- The telecommunications infrastructure will be provided per the Owner's requirements and all installations will comply with applicable BICSI and ANSI/TIA guidelines.

Security:

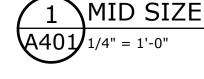

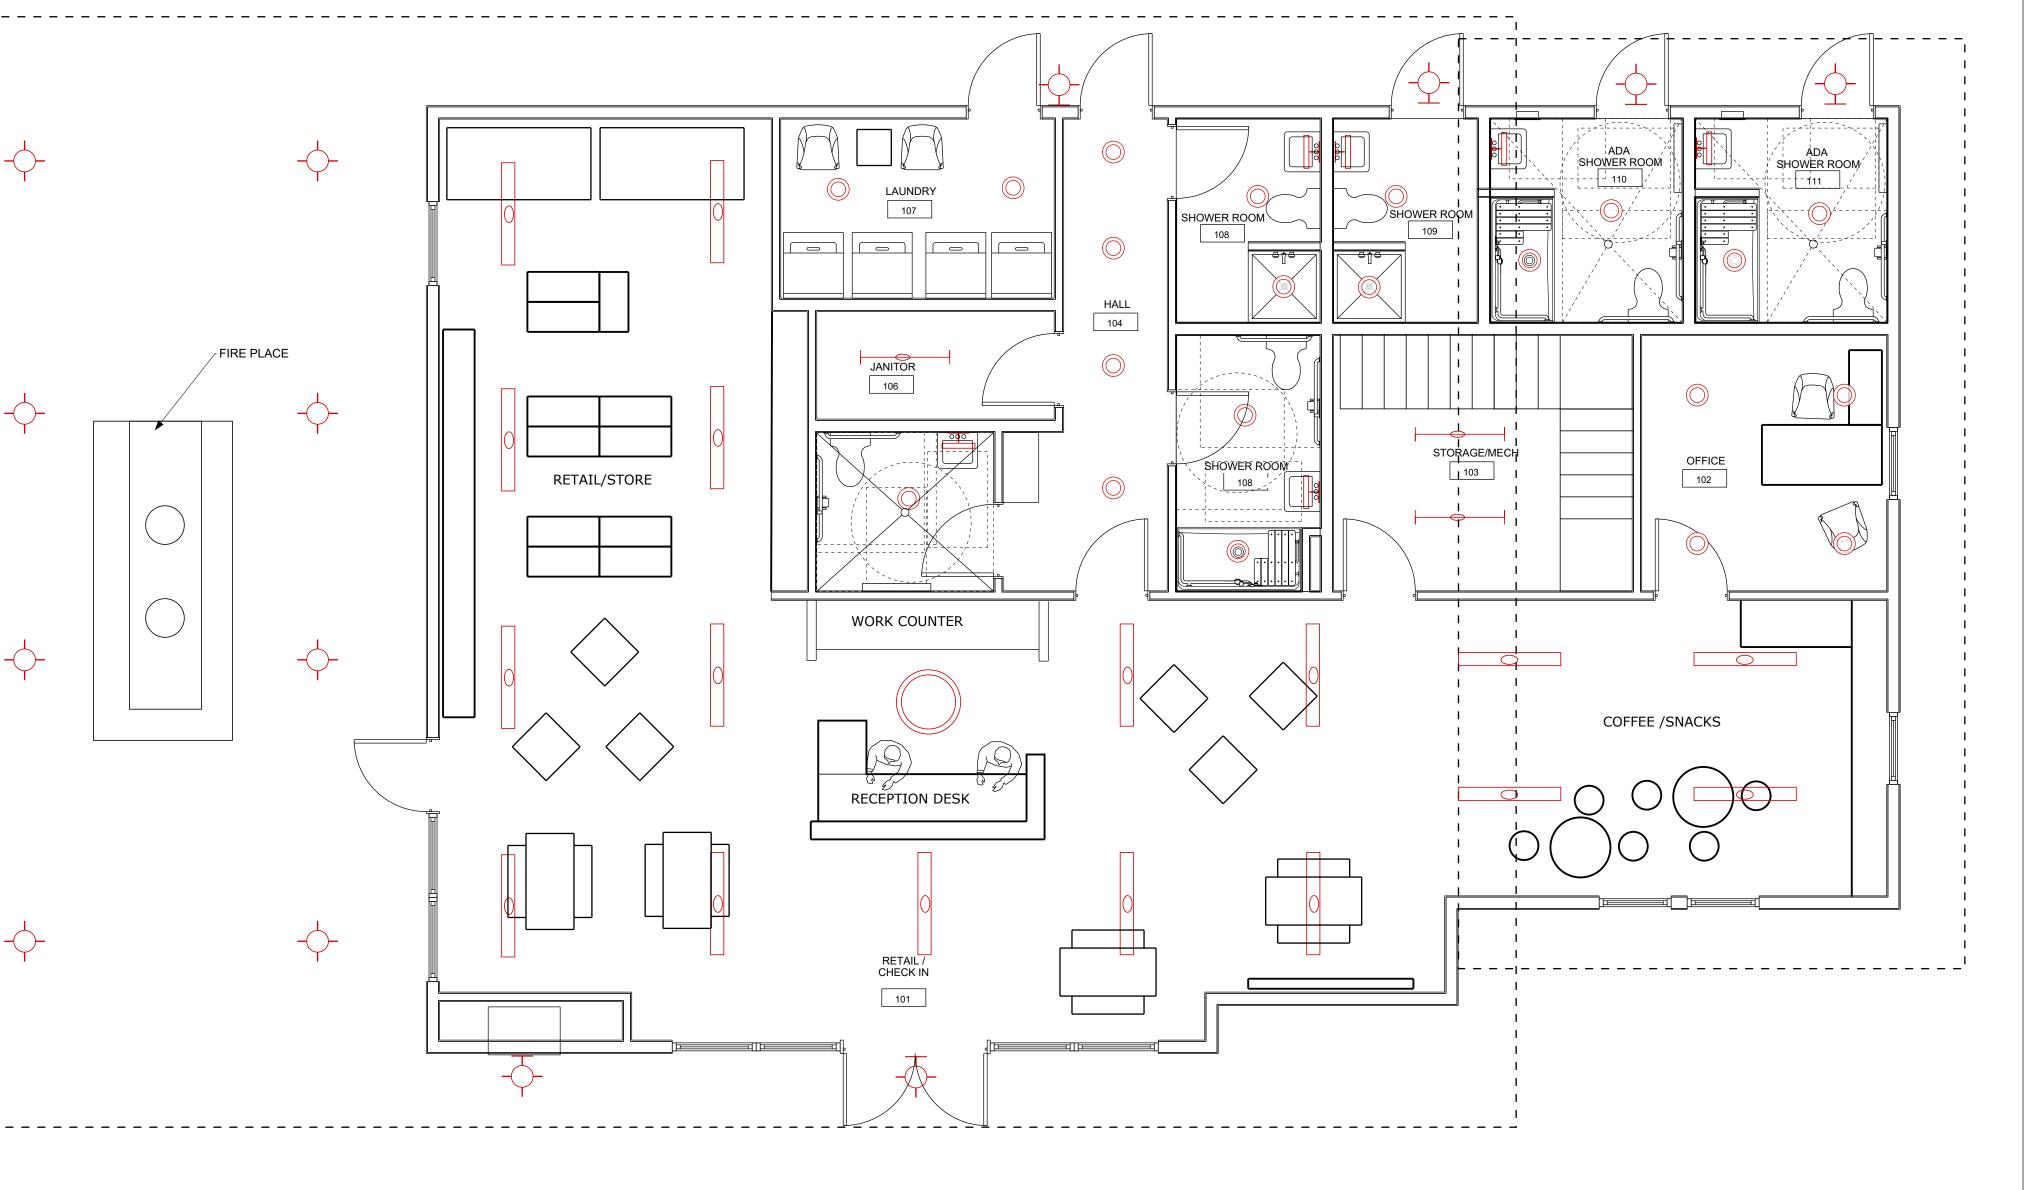

1 MID SIZE LIGHTING PLAN



CHECK-IN BUILDING/STOR PROTOTYPE

© 2021 I ALL RIGHTS RESERVED

NOT FOR CONSTRUCTION

DRAWN BY - Hendricks CHECKED BY -DATE 09.10.21

MID SIZE LIGHTING PLAN



KOA Documents - Mid Size, September 10, 2021

[•] Rough-in for an access control system will be included if owner requests. An access control system could include card readers, exterior door contacts and a main security panel. This would need to be incorporated with any ADA door controllers.